

	SHEET LIST
#	SHEET NAME
AO.01	COVER SHEET
A1.01	SITE PLAN & GENERAL NOTES
A1.02	CONTEXT PLAN
A2.01	FOUNDATION PLAN
A2.02	BASEMENT FLOOR PLAN
A2.03	MAIN FLOOR PLAN
A2.04	UPPER FLOOR PLAN
A2.05	ROOF PLAN
A3.01	FRONT \$ RIGHT ELEVATIONS
A3.02	REAR & LEFT ELEVATIONS
A3.03	MATERIAL BREAKDOWN
A4.01	CROSS SECTION A



No.	Description	Date

IOTES:



ALL DIMENSIONS TO BE CHECKED BY CONTRACTOR BEFORE START OF CONSTRUCTION & ANY DISCREPANCIES REPORTED.

THESE DRAWINGS CONFORM TO THE LATEST EDITION OF THE 2018 BRITISH COLUMBIA BUILDING CODE

PROJECT NUMBER: MDG22-112

DRAWN BY: CHECKED BY: MB

DATE: SCALE:

DATE: 23-08-30

SHEET TITLE:

COVER SHEET

ADDRESS:

5135 208A STREET LANGLEY

DRAWING:

A0.01

CIVIC ADDRESS:		SHEET LIST	
		#	SHEET NAME
5135 208A STREET LANG	I EV	AO.01	COVER SHEET
3133 200A STRLLT LANG	LL T	A1.01	SITE PLAN & GENERAL NOTES
		A1.02	CONTEXT PLAN
Legal addri		A2.01	FOUNDATION PLAN
		A2.02	BASEMENT FLOOR PLAN
LOT: 233 NWP PL: 56744	P.I.D. 002-572-915	A2.03	MAIN FLOOR PLAN
LOT: 255 NWT TE: 56744	1.1.0. 002-372-913	A2.04	UPPER FLOOR PLAN
		A2.05	ROOF PLAN
CITE DECONO		A3.01	FRONT # RIGHT ELEVATIONS
SITE RECONC	<u>JILIATION:</u>	A3.02	REAR & LEFT ELEVATIONS
		A3.03	MATERIAL BREAKDOWN
LOT SIZE :	668.00 sq. m. or 7,190.53 sq. ft.	A4.01	CROSS SECTION A
ZONING: LOT COVERAGE: GROSS FLOOR AREA: BUILDING HEIGHT:	RSI MAX. 33% or 2,372.87 sq. ft. or 220.45 sq. m. PROP. : 32.45% or 2,333.08 sq. ft. or 216.75 sq. m. PROP. : 70.62% or 5,078.03 sq. ft. or 471.76 sq. m. MAX. : I I m PROP. : 9.73m	PARKING REQUIREMENTS :	REQUIRED: I BEDROOM UNIT = 1.5 SPACES >2 BEDROOM UNIT = 2 SPACES VISITOR = 0.2/UNIT 2 BEDROOM UNIT: 1 x 2 = 2 SPACE 3 BEDROOM UNITS: 2 x 2 = 4 SPACE VISITOR: 0.2 x 3 = 0.6 = 1 SPACE PROVIDED: GARAGE = 3 SPACES EXTERIOR PARKING = 4 TOTAL = 7 SPACES
			TOTAL - 7 STACES
NUMBER OF STROEYS :	3 STOREYS		
EXISTING AVG. GRADE :	8.32m + 7.92m + 8.06m + 8.11m = 32.41m; $32.41m/4 = 8.10m$		
# OF DWELLING UNITS :	3 DWELLING UNIT; GROUP C		

GENERAL NOTES

CONTRACTOR.

FRONT :

INTERIOR (LEFT):

BUILDING SETBACKS:

I. ALL CONSTRUCTION SHALL BE CONDUCTED BY THE BUILDER/CONTRACTORS WITH THE LATEST ADOPTED ADDITION OF THE B.C. BUILDING CODE AT THE DATE OF ISSUANCE, AND ALSO CONFORM BY THE LOCAL GOVERNING CODES AND BYLAWS OF THE CITY OF LANGLEY.

MIN. - 7.50m PROP. - 9.45m

PROP. -1.50m

MIN. - 6.00m

MIN. - 1.50m

PROP. - 3.73m


PROP. - 6.50m

INTERIOR (RIGHT): MIN. - 1.50m

- 2. THE GENERAL CONTRACTOR AND ANY RETAINED BUILDING TRADES CONTRACTORS ARE RESPONSIBLE TO REVIEW THESE PLANS BEFORE ANY BUILDING MATERIALS ARE ORDERED AND ANY SITE WORK OR CONSTRUCTION COMMENCES. ALL DISCREPANCIES OR ERRORS ARE TO BE REPORTED TO METHOD DESIGN GROUP LTD. IMMEDIATELY.
- 3. THESE DRAWINGS ARE NOT INTENDED TO BE SCALED. SCALED NOTED ON PLANS IS FOR VISUAL ORIENTATION ONLY. IF A DISCREPANCY IS FOUND, THE BUILDING/CONTRACTOR IS TO CONTACT METHOD DESIGN GROUP LTD. FOR INTERPRETATION OF THE INTENT OR CLARIFICATION BEFORE WORK COMMENCES.
- 4. THE BUILDER/CONTRACTOR IS TO SUPPLY METHOD DESIGN GROUP WITH ANY AND ALL ENGINEERED DRAWINGS OR SHOP DRAWINGS FOR REVIEW. REVIEW OF SHOP DRAWINGS BY METHOD DESIGN GROUP LTD. IS FOR CONFORMANCE WITH THE DESIGN CONCEPT OF THE
- 5. THE SITING OF ANY BUILDING TO BE CONFIRMED BY A LEGAL LAND SURVEY, AND NEEDS TO CONFORM TO THE LOCAL GOVERNING BYLAWS REGARDING BUILDING SETBACKS BEFORE
- G. THE BUILDER/CONTRACTOR HALL MAINTAIN AS BUILT DRAWINGS FOR ANY CHANGES DURING CONSTRUCTION.
- 7. ALL CONCRETE IS TO BE PLACED ON A FIRM, SOLID, GRADE, WITH NO LOOSE OR FROSTED MATERIAL.
- 8. ALL BUILDING MATERIAL SHALL BE NEW UNLESS NOTED OTHERWISE. LUMBER IS TO BE SPF
- 9. BUILDING MATERIAL SUBSTITUTIONS SHALL HAVE EQUAL OR GREATER REQUIREMENTS THAN THE
- MATERIAL BEING REPLACED.

10. A MINIMUM OF TWO HOSE BIBS SHALL BE INSTALLED, LOCATION TO BE SUPPLIED BY THE

- II. ALL EXTERIOR AND ENTRANCE DOORS SHALL HAVE A DEADBOLT ASSEMBLY, AND SHALL BE
- SOLID BLOCKED AS TO RESIST SPREADING DURING FORCIBLE ENTRY.
- I 2. ALL EXTERIOR DOOR HINGES SHALL BE INSTALLED AS SUCH THAT THE DOORS CANT BE REMOVED FROM THE EXTERIOR.
- 13. ALL STAIRS, LANDING, BALCONIES AND OPENING AROUND STAIRWELLS SHALL HAVE GUARDS AND HANDRAILS DESIGNED AND CONSTRUCTED IN ACCORDANCE WITH THE CURRENT BUILDING CODE REQUIREMENTS.
- 14. WITHIN DWELLING UNITS, ELECTRICALLY CONNECTED SMOKE ALARMS SHALL BE INSTALLED ON EACH STOREY, INCLUDING THE BASEMENT. SMOKE ALARMS SHALL ALSO BE INSTALLED IN EACH BEDROOM/SLEEPING AREA IN THE DWELLING UNIT.
- 15. CARBON MONOXIDE ALARMS SHALL BE INSTALLED IN ANY DWELLING UNIT CONTAINING A FUEL BURNING APPLIANCE OR ATTACHED STORAGE GARAGE. WHERE A ROOM CONTAINS A FUEL BURNING APPLIANCE, A CARBON MONOXIDE ALARM SHALL BE INSTALLED IN THE ROOM.
- THE WALL SEPARATING A GARAGE AND DWELLING UNIT SHALL BE MADE FUME PROOF, AND THE DOORS BETWEEN THE GARAGE AND THE DWELLING UNIT SHALL BE WEATHER STRIPPED AND FITTED WITH A SELF CLOSING DEVICE. THIS ALSO APPLIES TO FURNACE ROOM LOCATED IN
- 17. ROOF SOFFITS LOCATED WITHIN 1.2m OF A PROPERTY LINE SHALL NOT CONTAIN ANY OPENING.
- 18. VAPOUR/AIR BARRIERS MUST BE 6 MIL. U.V. RESISTANT TYPE POLY AND MUST BE CONTINUOUS WHERE INTERIOR WALLS MEET EXTERIOR WALLS OR ATTIC CEILINGS, AND WHERE STAIRS, TUBS, OR SHOWERS ARE ATTACHED TO INSULATED WALLS.
- 19. MINIMUM INSULATION VALUES SHALL CONFORM TO THE CURRENT B.C. BUILDING CODE.
- 20. HOLES THROUGH THE VAPOUR BARRIERS SHALL BE SEALED.
- 21. ALL TRUSSES ARE TO BE ENGINEERED. SPANS AND DETAILS TO BE VERIFIED BY THE TRUSS SUPPLIER ON SITE PRIOR TO ANY FABRICATION.
- 22. ALL DOORS AND WINDOWS SHALL COMPLY WITH NAFS HARMONIZED STANDARD REGULATION FOR MANUFACTURED DOORS, WINDOWS, AND SKYLIGHTS, AAMAWDMA/CSA 101/I.S.2/A440, "NAFS NORTH AMERICAN FENESTRATION STANDARD/ SPECIFICATION FOR WINDOWS, DOORS, AND SKYLIGHTS" AND A440S1-09 CANADIAN SUPPLEMENT TO AAMAWDMA/CSA 101/I.S.2/A440.

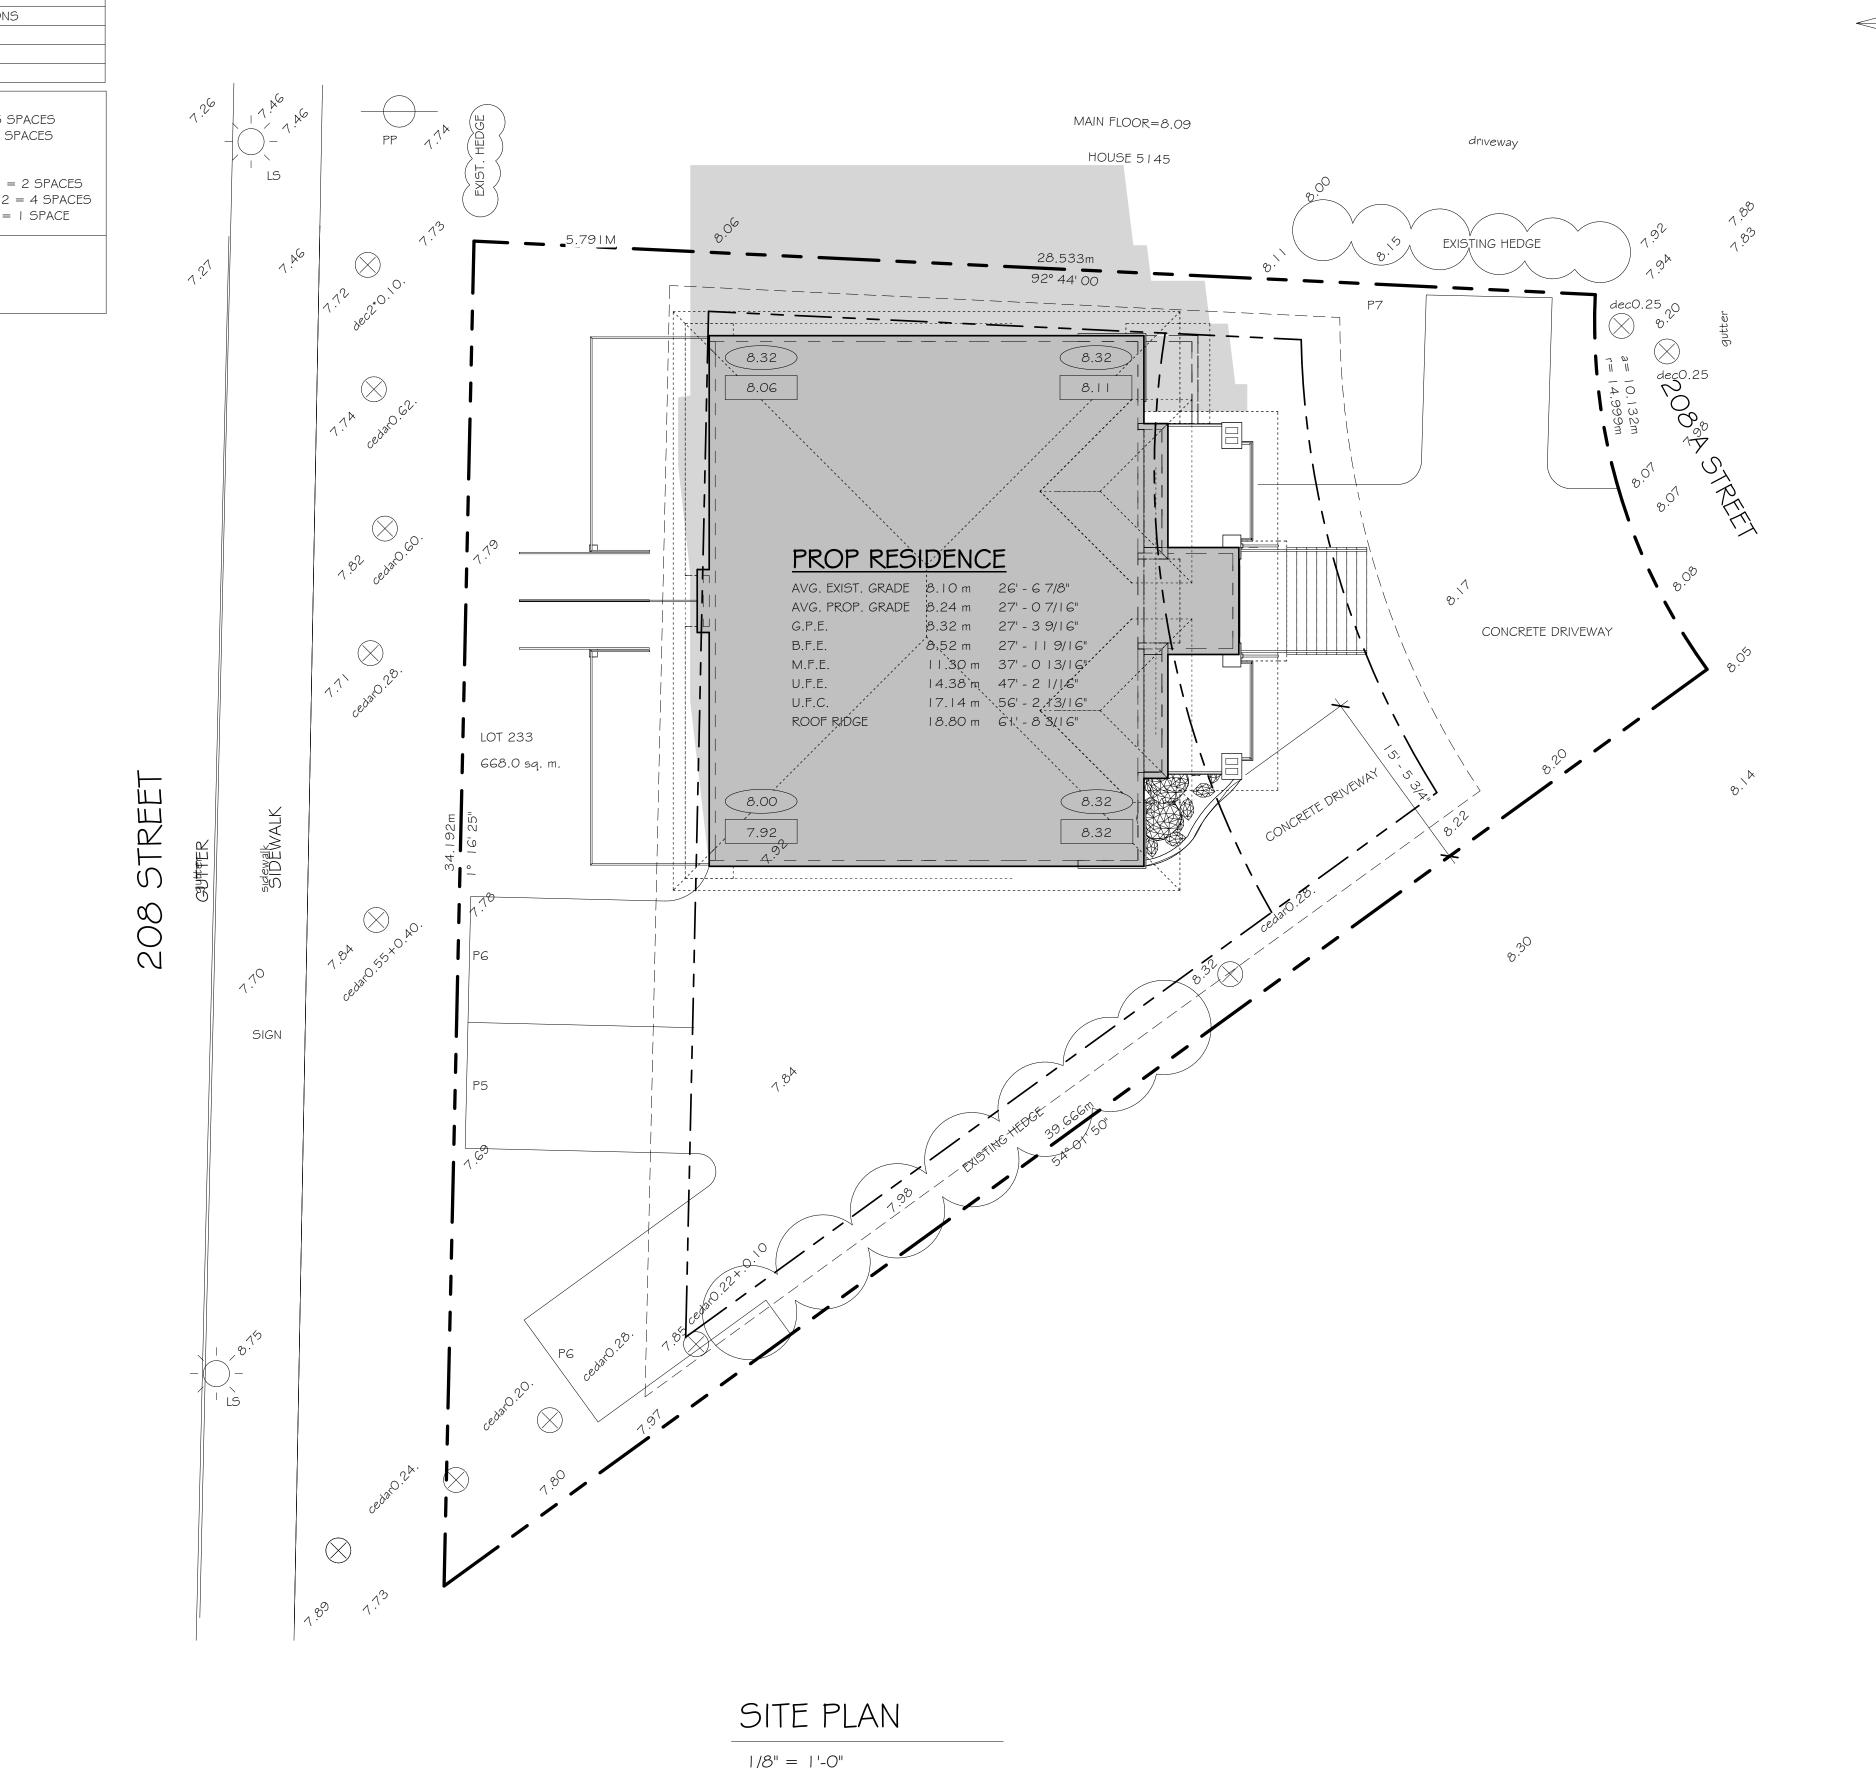



UNIT #202-34654 DELAIR RD.
ABBOTSFORD, B.C. V2S 2C9
TEL: (604) 217-9097
WWW.METHODDESIGNGROUP.COM

No.	Description	Date

OTES:

- GLAZING IN EXTERIOR DOORS & GLAZING WITHIN 3'-O" OF EXTERIOR DOORS TO BE SAFETY GLASS

- GLAZING ENCLOSED SHOWERS \$
BATH TUBS TO BE SAFETY GLASS

- GLAZED GUARDRAILS TO BE CONSTRUCTED OF SAFETY GLASS

- ALL GUARDRAILS TO BE DESIGNED \$ CONSTRUCTED AS PER BC BUILDING CODE 9.8.8.

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CODE SECTION 9.8.7. CODE SECTION
9.7

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THESE DRAWINGS CONFORM TO THE LATEST EDITION OF THE 2018 BRITISH COLUMBIA BUILDING CODE

PROJECT NUMBER: MDG22-112

DRAWN BY: CHECKED BY: MB

DATE: SCALE:

SHEET TITLE:

23-08-30

SITE PLAN & GENERAL NOTES

1/8" = 1'-0"

ADDRESS:

5135 208A STREET LANGLEY

DRAWING:

A1.01








CONTEXT PLAN

1/4" = 1'-0"

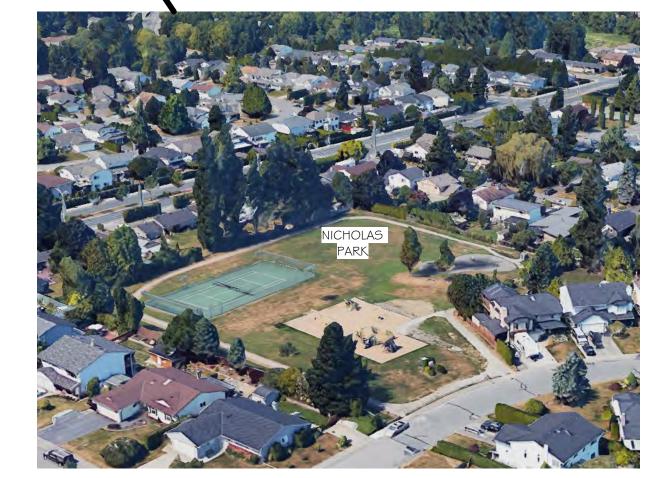



UNIT #202-34654 DELAIR RD. ABBOTSFORD, B.C. V2S 2C9 TEL: (604) 217-9097 WWW.METHODDESIGNGROUP.COM

No.	Description	Date

NOTE

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	PROJECT NUMBER:		
MDG22-112	MDG22-112		
DRAWN BY:	CHECKED BY:		
NJ	IVID		
DATE:	SCALE:		
23-08-30	1/4" = 1'-0"		

SHEET TITLE:


CONTEXT PLAN

ADDRESS:

5135 208A STREET LANGLEY

DRAWING:

A1.02

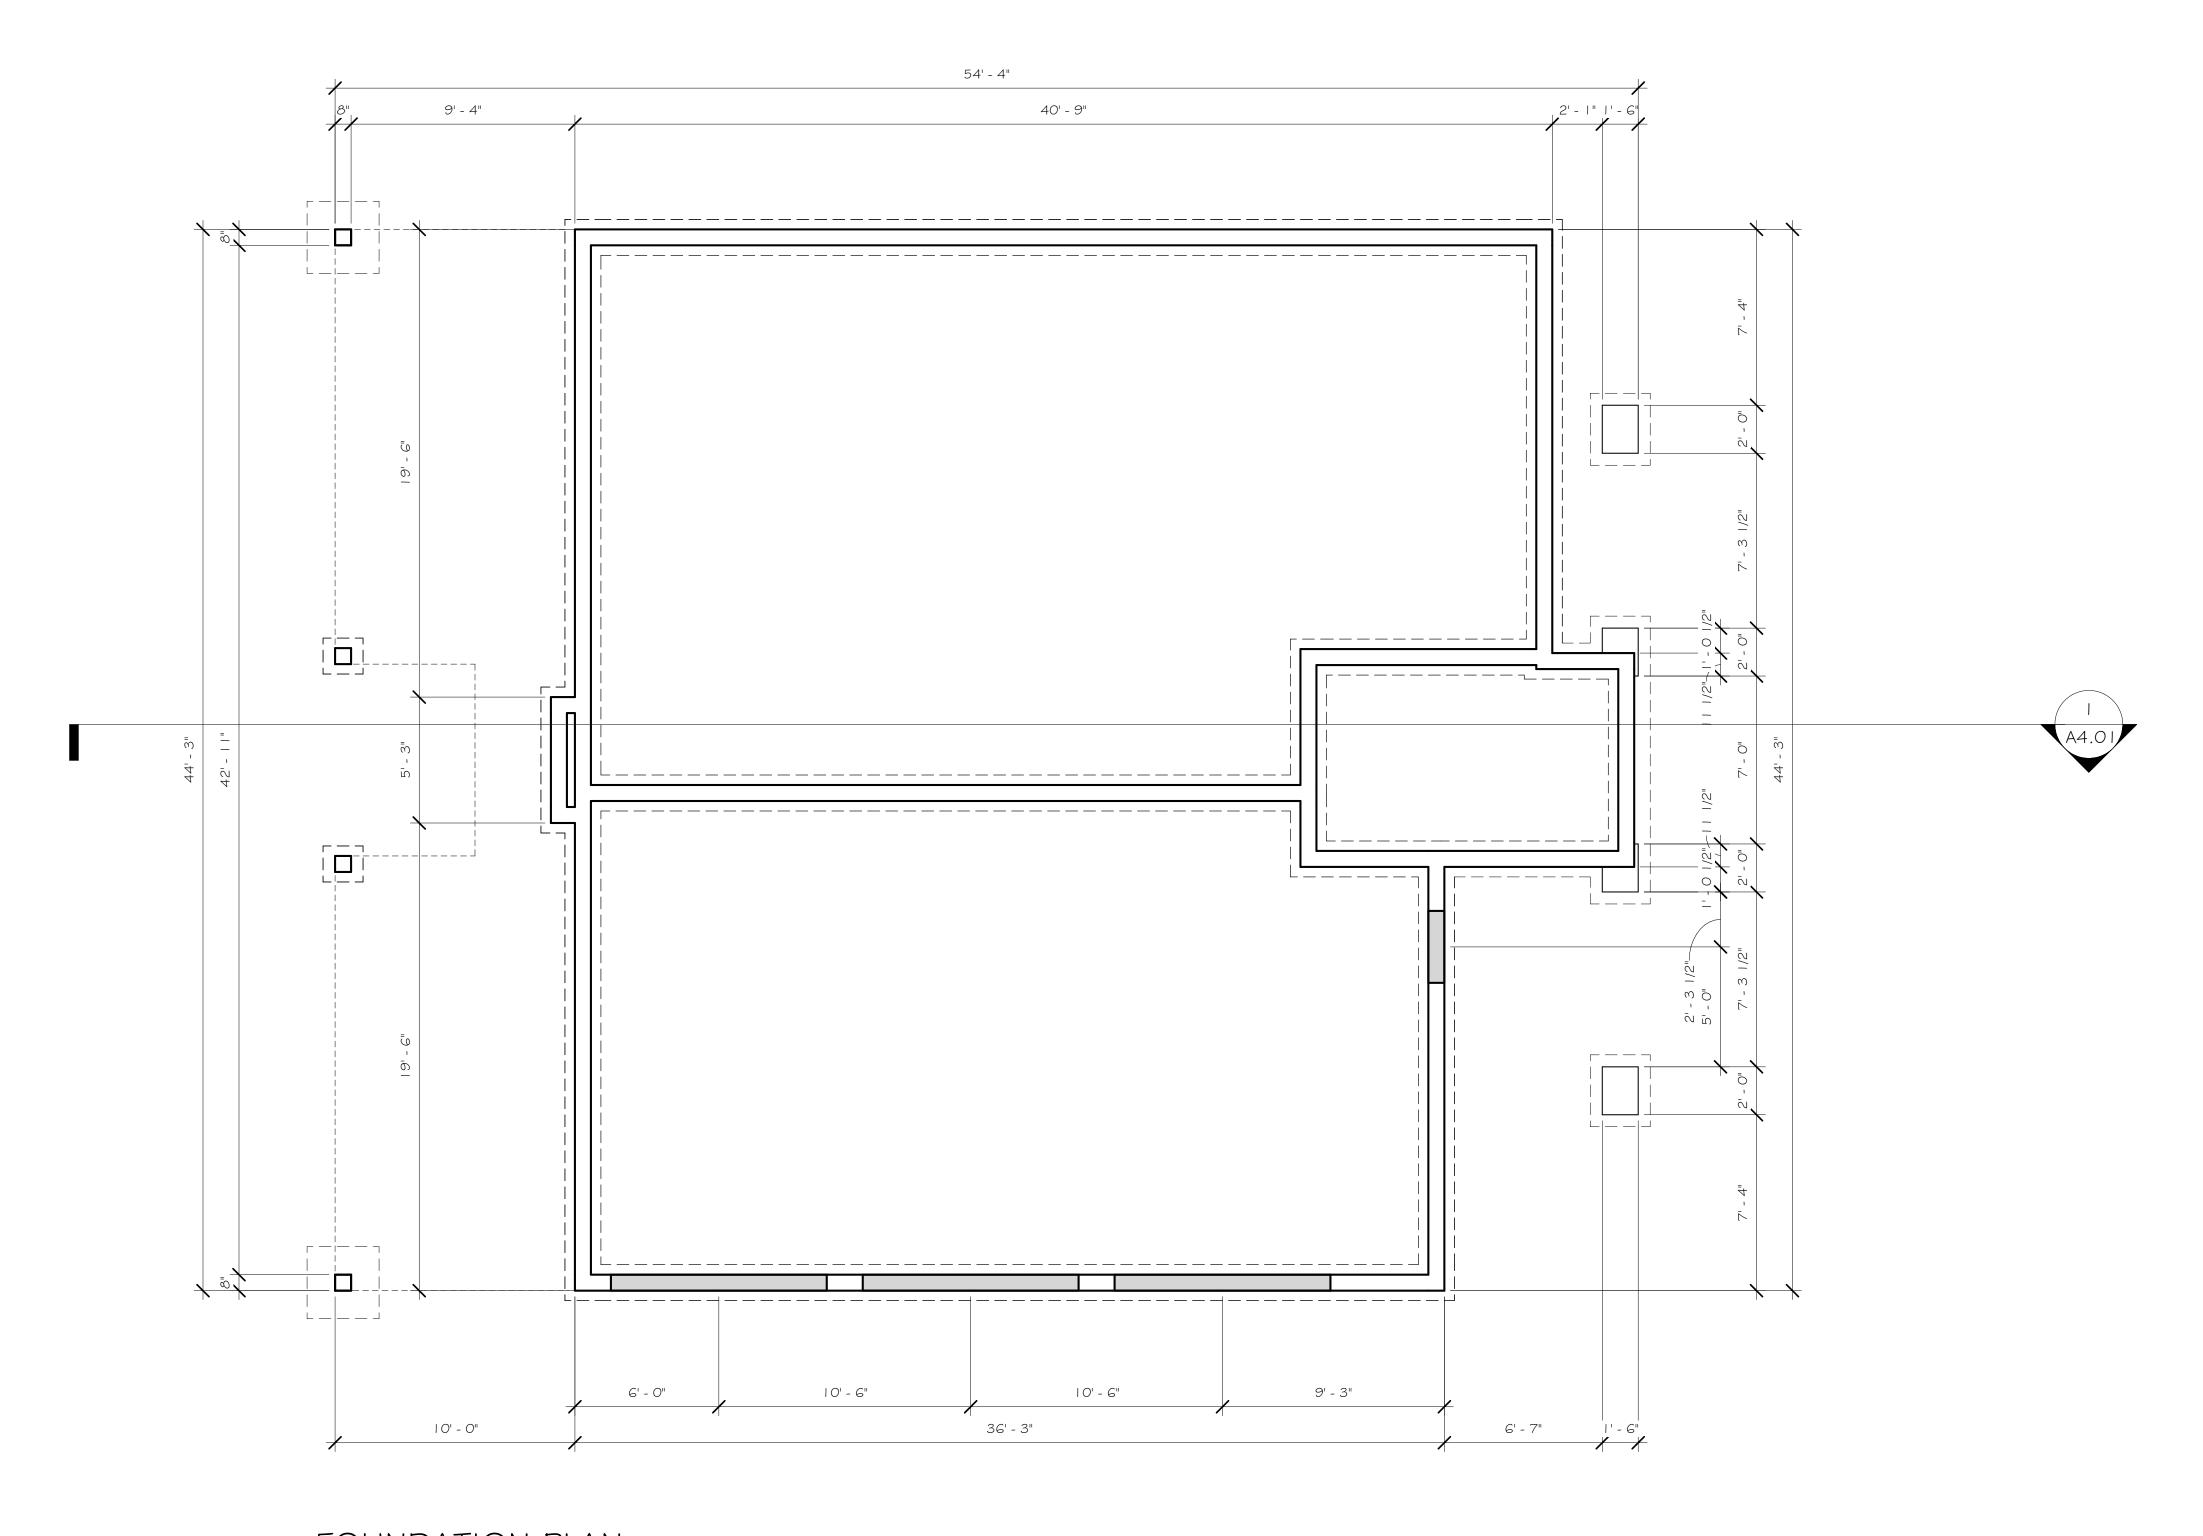

FOUNDATION PLAN

1/4" = 1'-0"



UNIT #202-34654 DELAIR RD. ABBOTSFORD, B.C. V2S 2C9 TEL: (604) 217-9097 WWW.METHODDESIGNGROUP.COM

No.	Description	Date

NOTE

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GLAZING WITHIN 3'-O" OF EXTERIOR
DOORS TO BE SAFETY GLASS

- GLAZING ENCLOSED SHOWERS & BATH TUBS TO BE SAFETY GLASS

- GLAZED GUARDRAILS TO BE CONSTRUCTED OF SAFETY GLASS

- ALL GUARDRAILS TO BE DESIGNED \$
CONSTRUCTED AS PER BC BUILDING
CODE 9.8.8.

- ALL HANDRAILS TO BE DESIGNED & CONSTRUCTED AS PER B.C. BUILDING CODE SECTION 9.8.7. CODE SECTION 9.7

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CHECKED BY:

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	PROJECT NUMBER: MDG22-112	
	DRAWN BY:	

RJ	MB
DATE: 23-08-30	SCALE: 1/4" = 1'-0"
20 00 00	


SHEET TITLE:

FOUNDATION PLAN

ADDRESS:

5135 208A STREET LANGLEY

DRAWING:

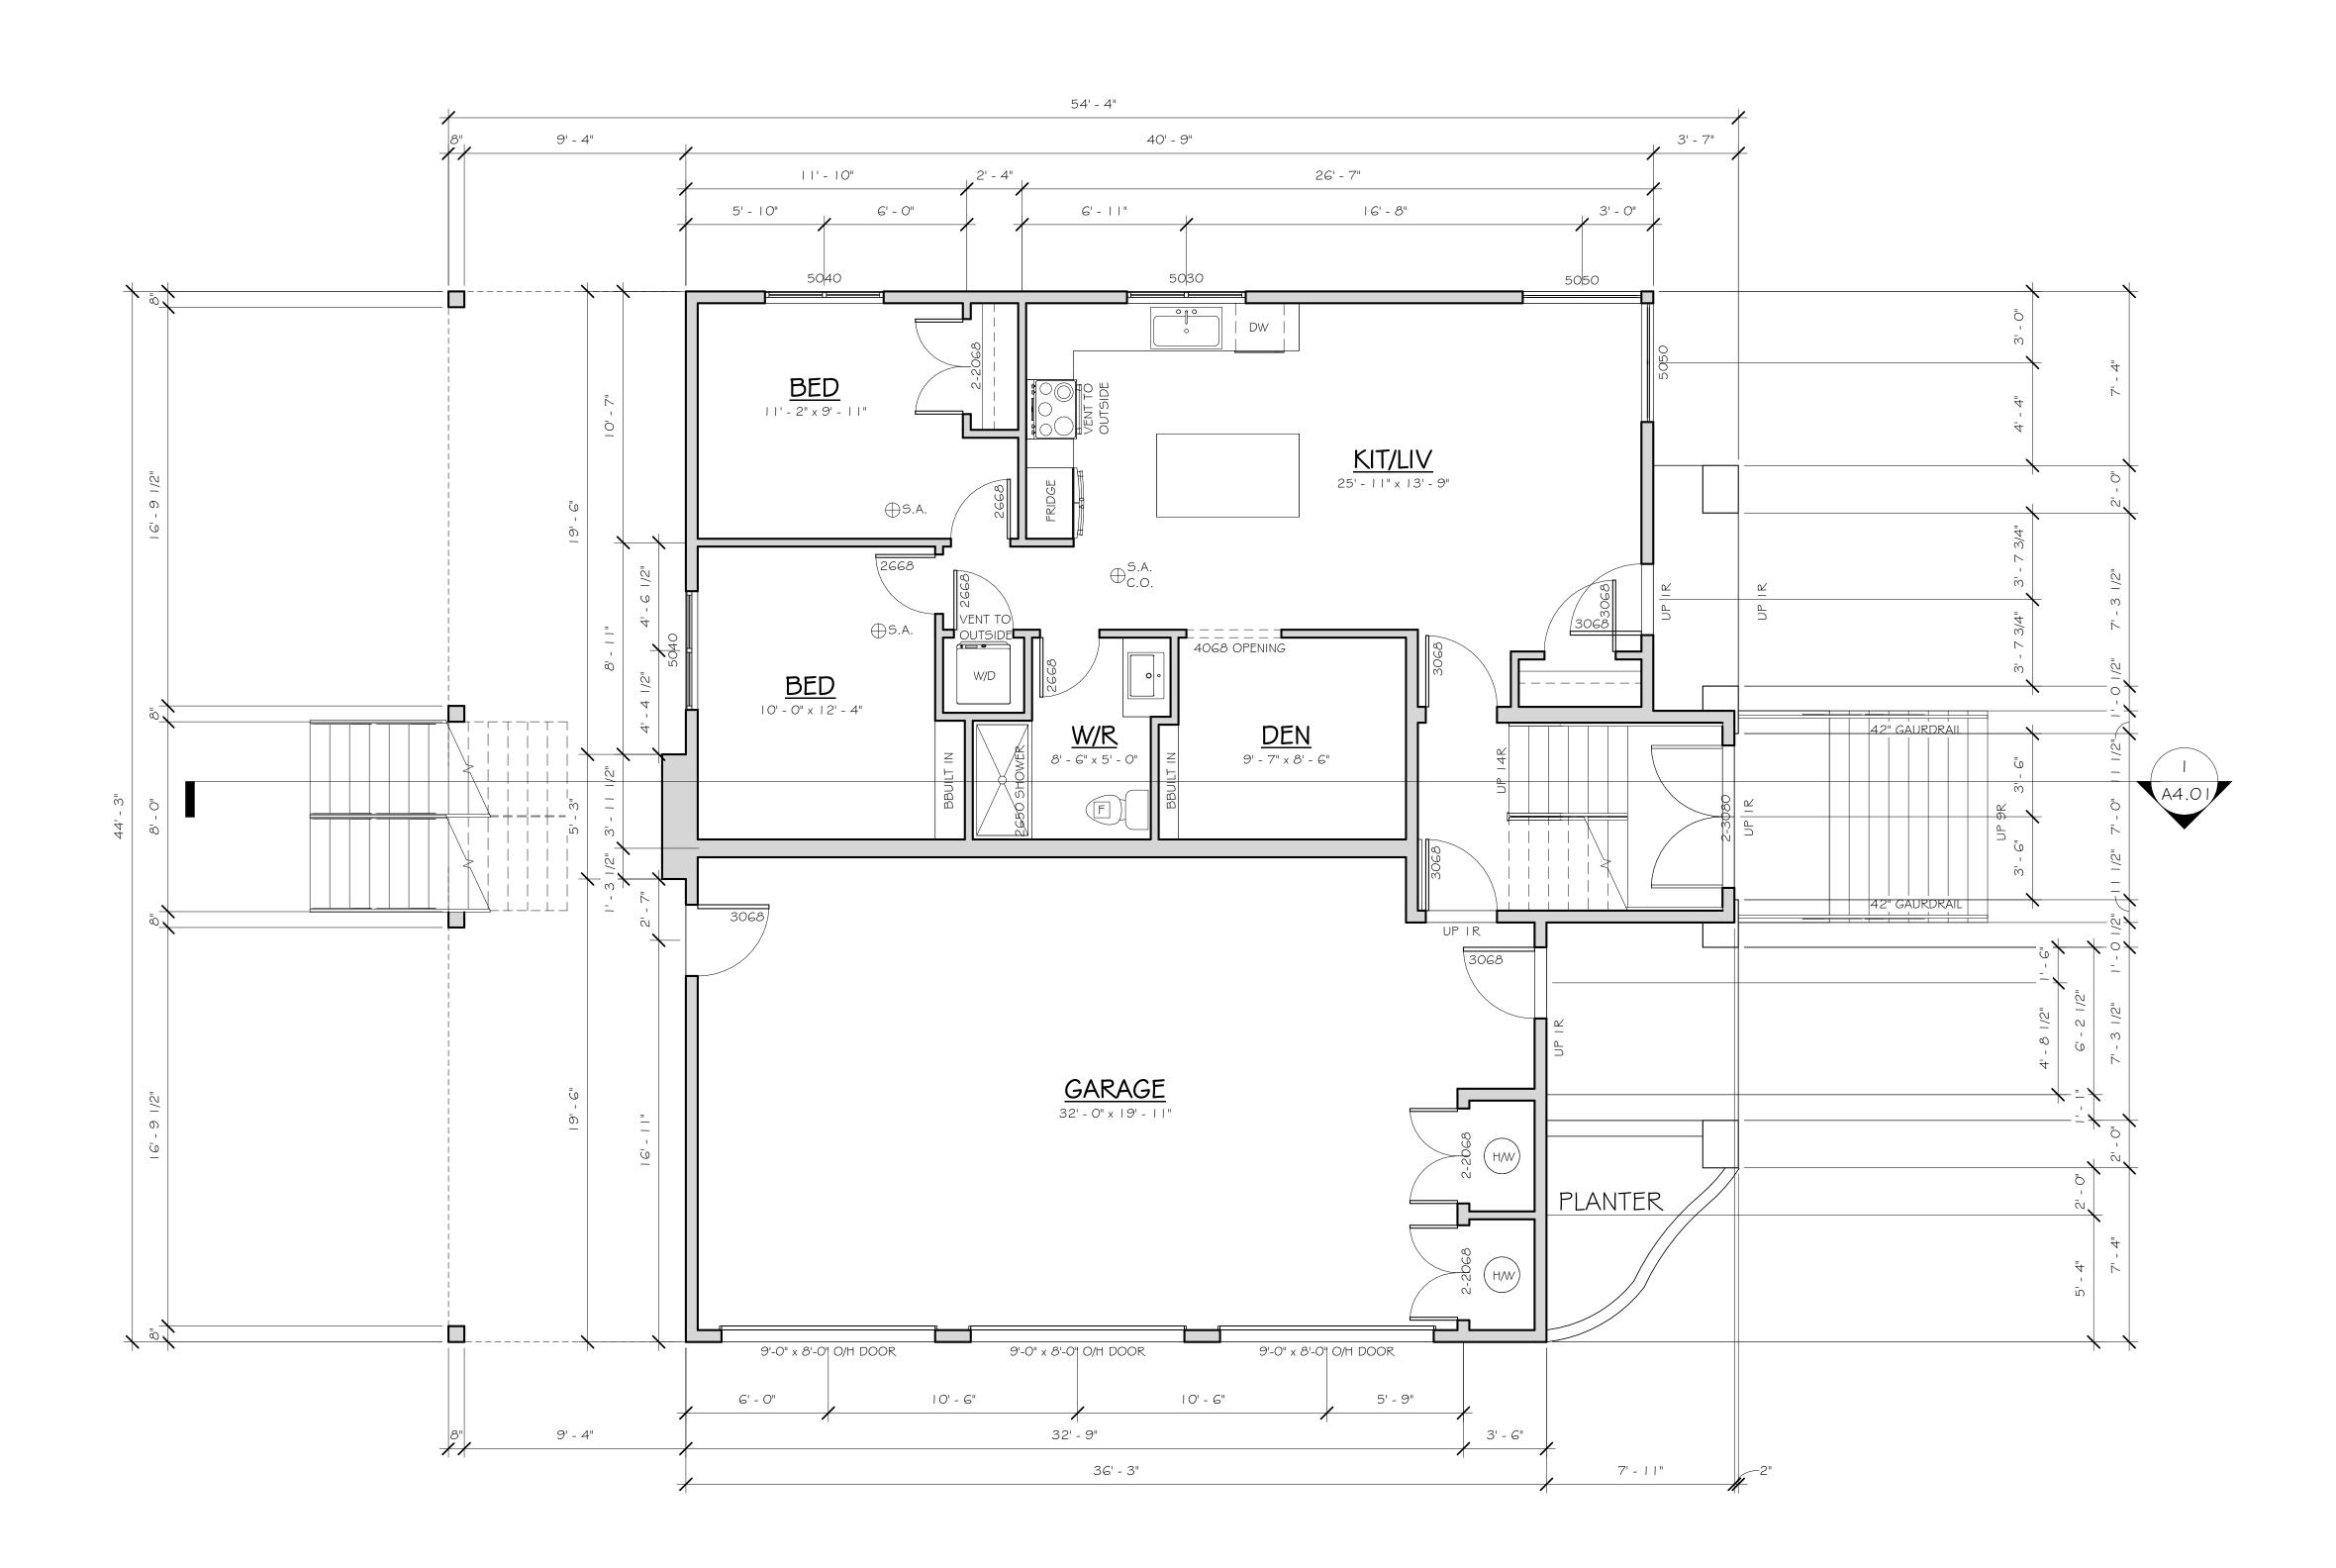

BASEMENT FLOOR

COMMON AREA 127.07 ft²
GARAGE 735.21 ft²
UNIT 1 LIVING 891.88 ft²
TOTAL AREA: 1,754.15 ft²



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	DRAWN BY:	

RJ	MB
DATE:	SCALE:
23-08-30	1/4" = 1'-0"

SHEET TITLE:


BASEMENT FLOOR PLAN

CHECKED BY:

ADDRESS:

5135 208A STREET LANGLEY

DRAWING:

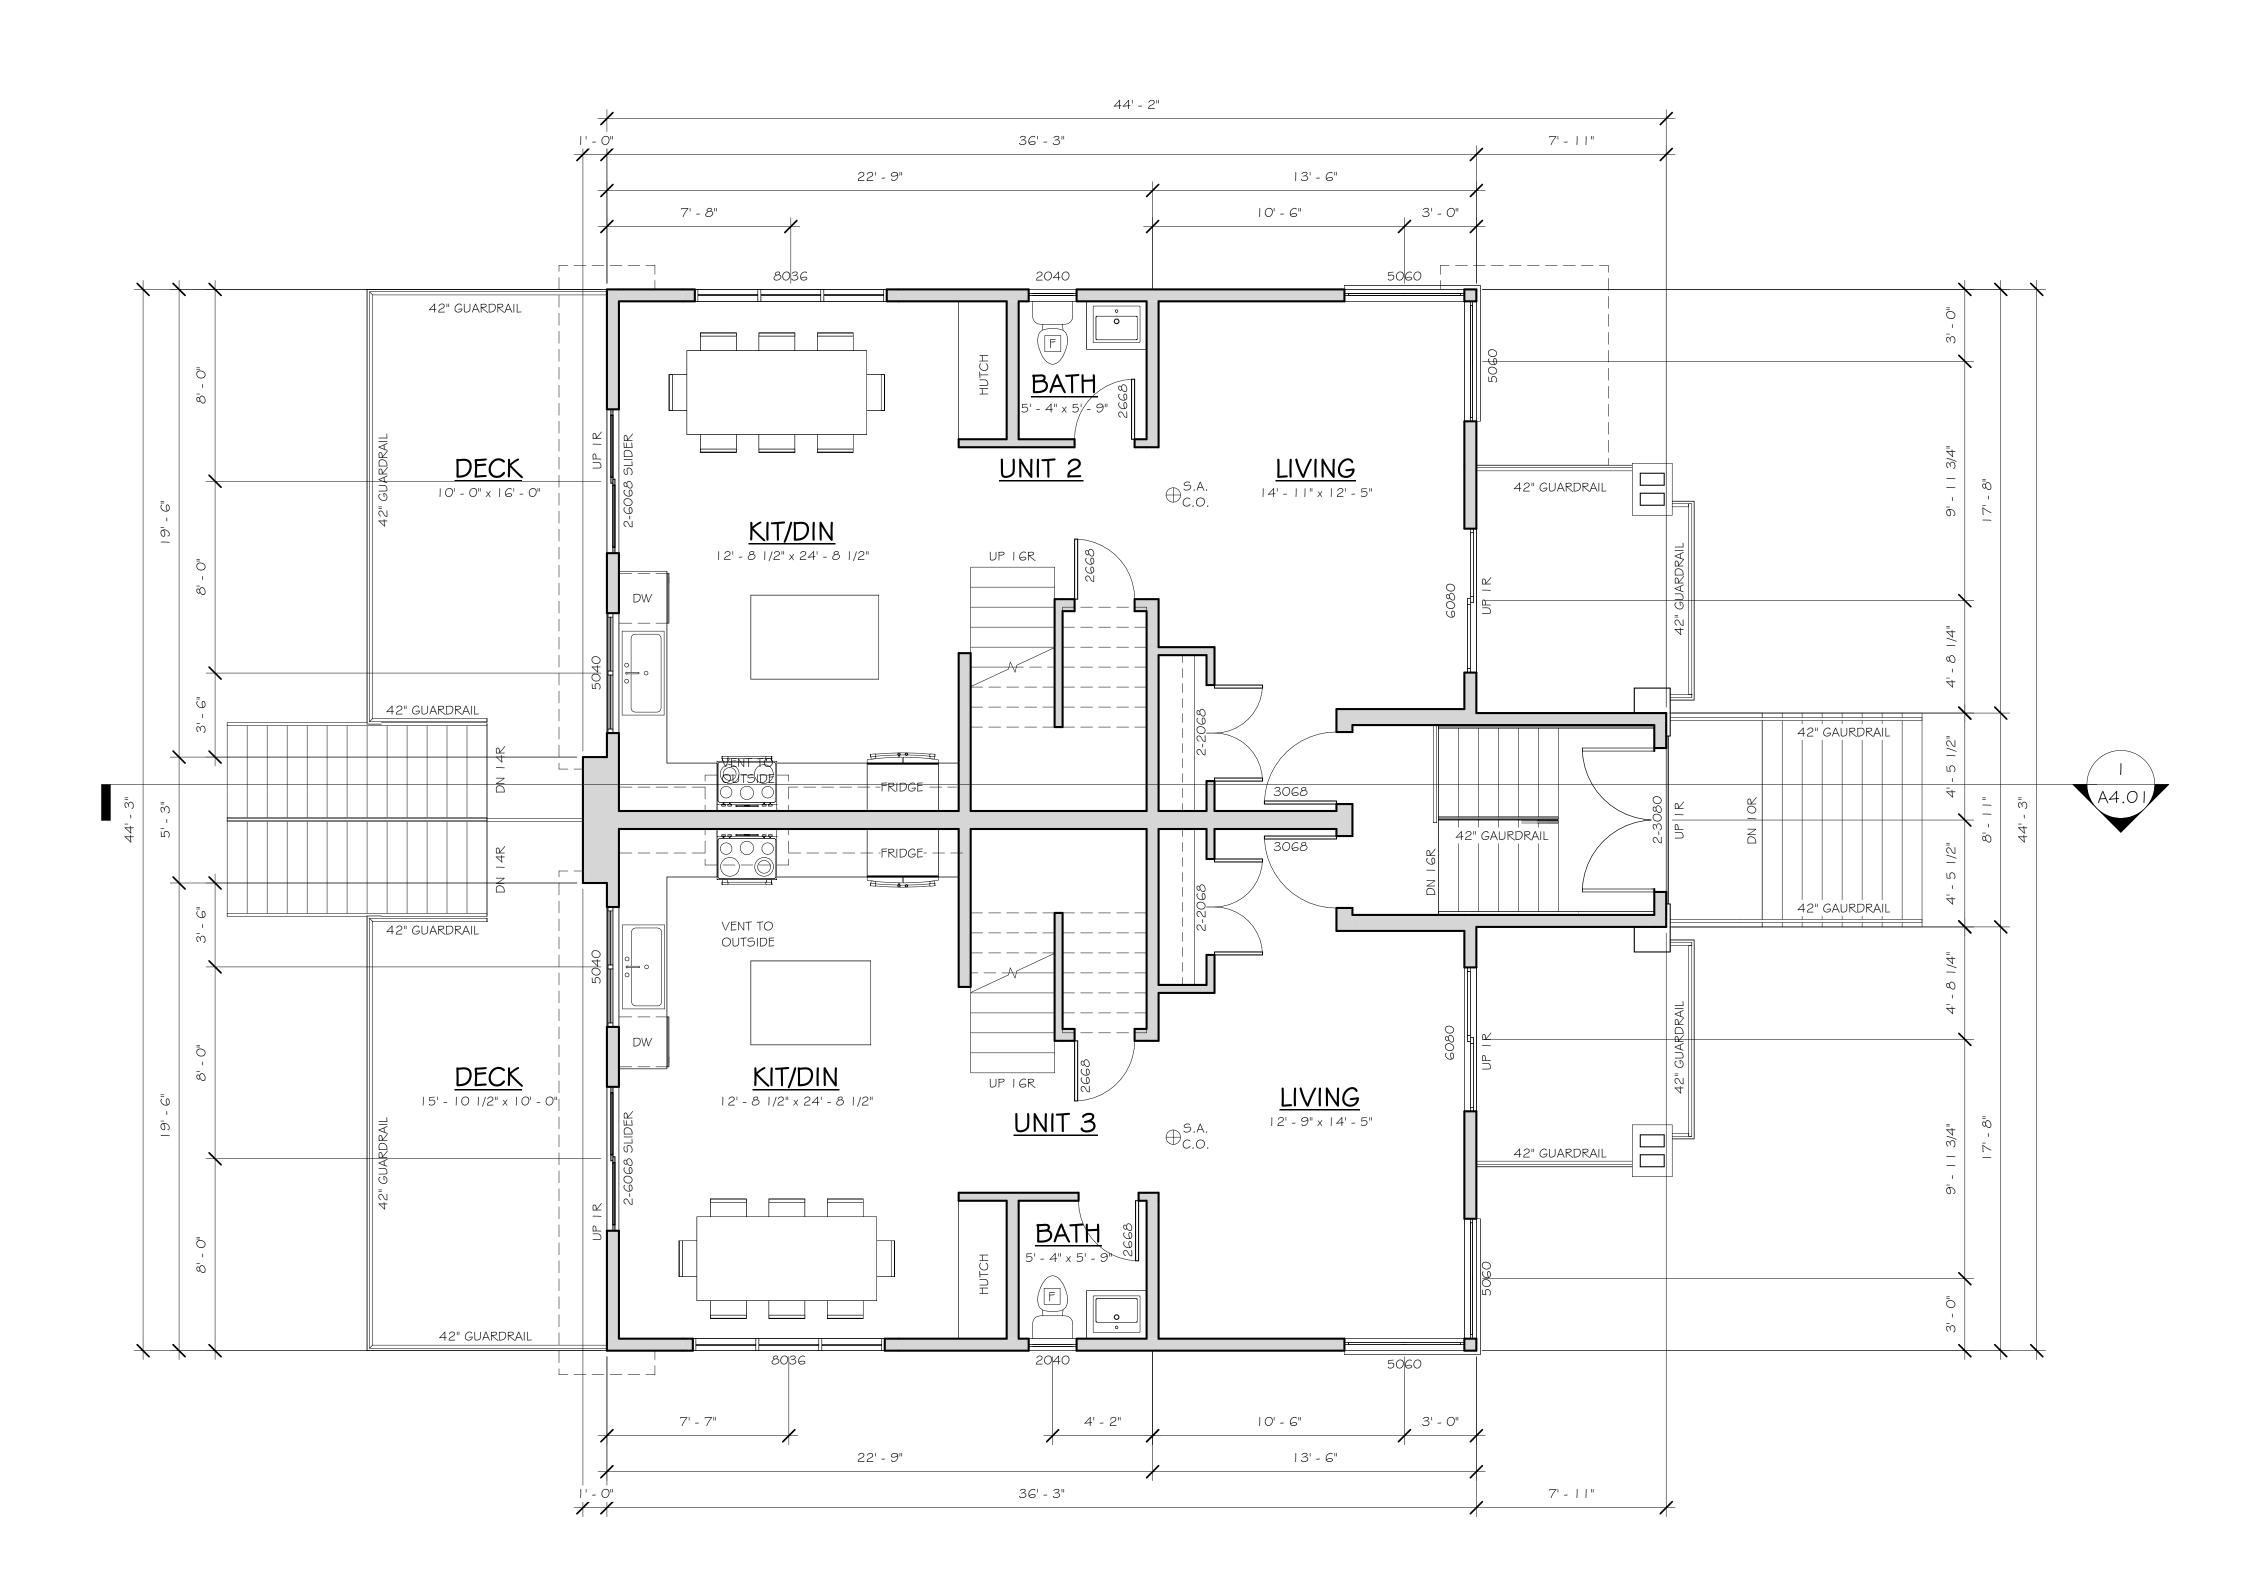

MAIN FLOOR

COMMON AREA 126.86 ft²
UNIT 3 LIVING 773.27 ft²
UNIT 2 LIVING 774.52 ft²
TOTAL AREA: 1,674.65 ft²



UNIT #202-34654 DELAIR RD. ABBOTSFORD, B.C. V2S 2C9 TEL: (604) 217-9097 WWW.METHODDESIGNGROUP.COM

No.	Description	Date

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	MDG22-112
	DRAWN BY:
	DΙ

KJ	IVID
DATE: 23-08-30	SCALE: 1/4" = 1'-0"
	•

PROJECT NUMBER:


SHEET TITLE:

MAIN FLOOR PLAN

ADDRESS:

5135 208A STREET LANGLEY

DRAWING:

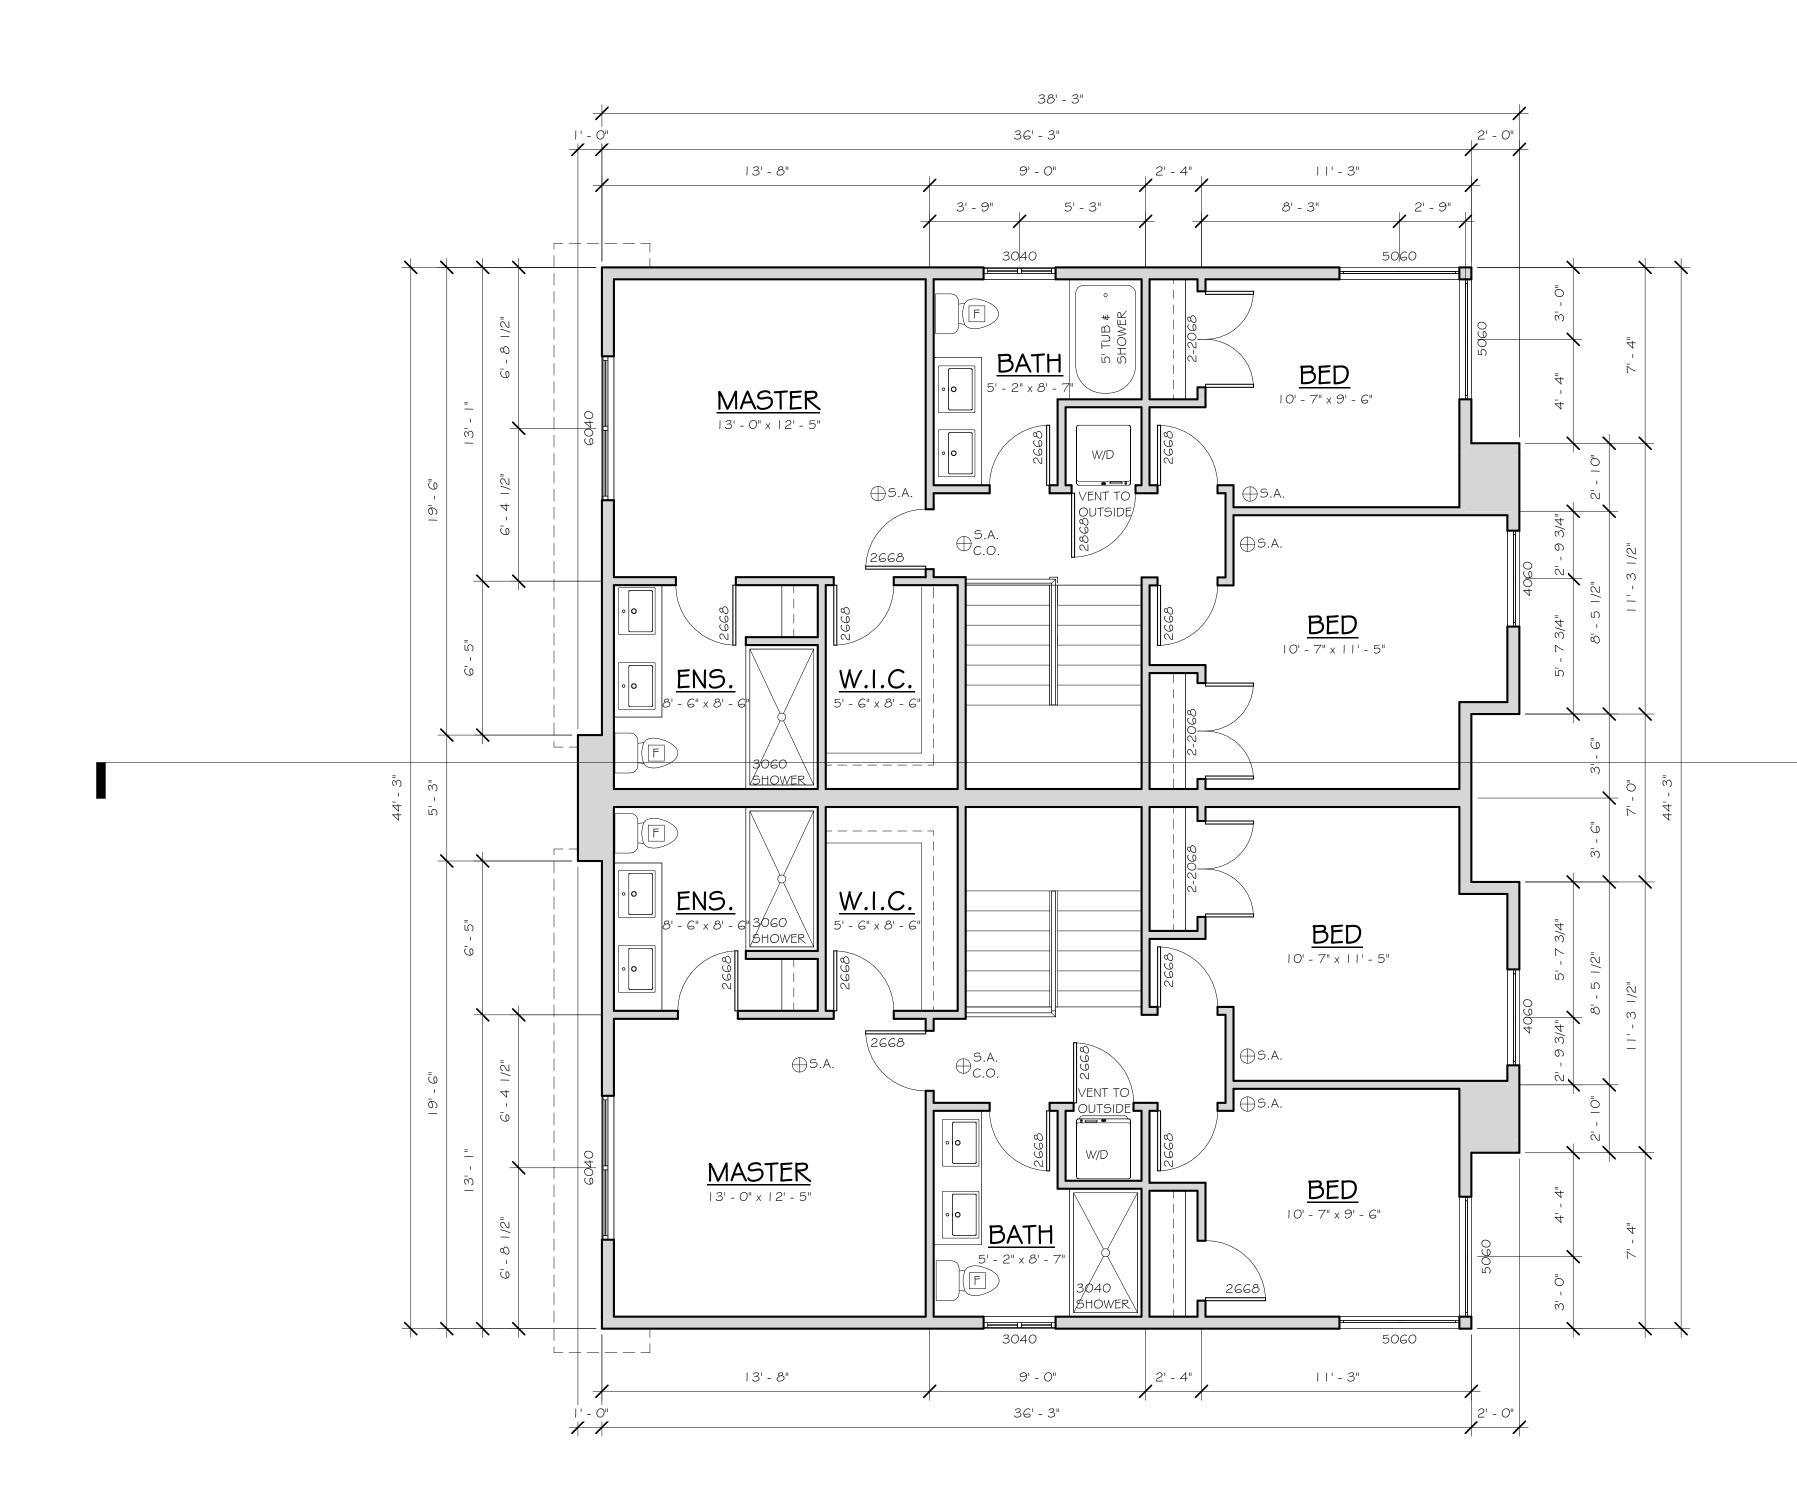





STAIRS | 124.67 ft² | 1,524.56 ft² | TOTAL AREA: | 1,649.23 ft²



UNIT #202-34654 DELAIR RD. ABBOTSFORD, B.C. V2S 2C9 TEL: (604) 217-9097 WWW.METHODDESIGNGROUP.COM

No.	Description	Date

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CHECKED BY:

	PROJECT NUMBER:
	MDG22-112
	DRAWN BY:
	RJ

1 10	IVID
DATE:	SCALE:
23-08-30	1/4" = 1'-0"
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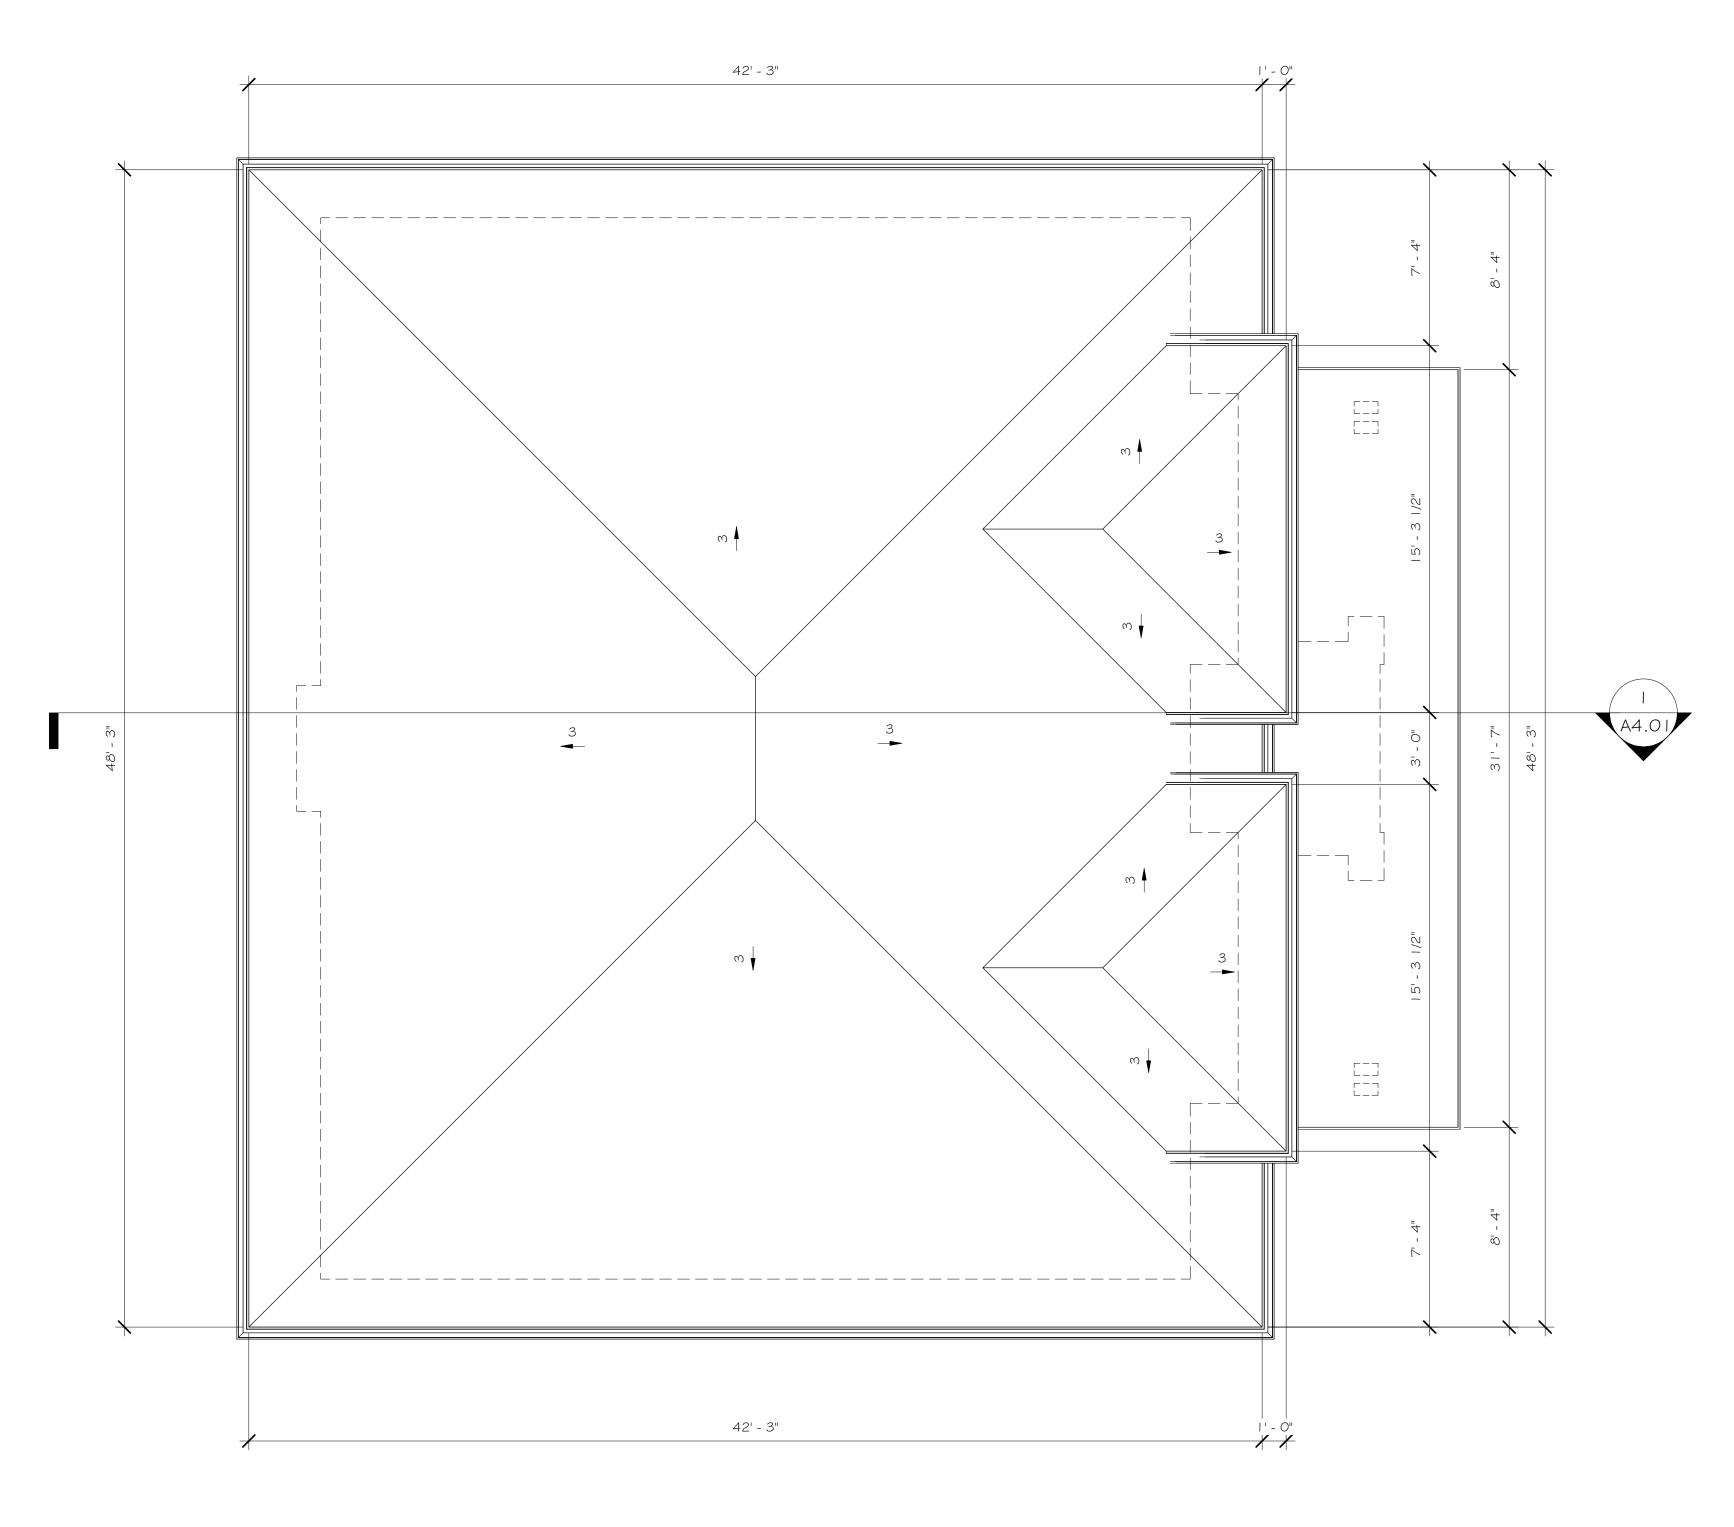
SHEET TITLE:

UPPER FLOOR PLAN

ADDRESS:

5135 208A STREET LANGLEY

DRAWING:



ROOF PLAN

1/4" = 1'-0"



UNIT #202-34654 DELAIR RD. ABBOTSFORD, B.C. V2S 2C9 TEL: (604) 217-9097 WWW.METHODDESIGNGROUP.COM

No.	Description	Date

NOTES

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MDG22-112

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DATE: 23-08-30	SCALE: 1/4" = 1'-0"

SHEET TITLE:

ROOF PLAN

ADDRESS:

5135 208A STREET LANGLEY

DRAWING:







No.	Description	Date

NOTES:

MATERIAL LEGEND

I STONE STYLE I

2 STONE STYLE 2

3 LONGBOARD

4 VINYL WINDOW

5 2 X 10 STONE BAND

6 I X 8 FASCIA BOARD W/ GUTTER

7 | X 6 ON | x 24 FASCIA BOARD W/ PAINTED FINISH

8 OVERHEAD DOOR

9 WOOD W/ STONE BASE COLUMN

10 ASPHALT ROOF SHINGLES

II GLASS GUARDRAILS

12 C-CHANNEL STEEL MEMBER

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PROJECT NUMBER: MDG22-112

DRAWN BY: CHECKED BY:
RJ MB

DATE: SCALE:
23-08-30 As indicated

SHEET TITLE:

FRONT & RIGHT ELEVATIONS

ELEVATIONS

ADDRESS:

5135 208A STREET LANGLEY

DRAWING:

A3.01







No.	Description	Date

NOTES:

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PROJECT NUMBER: MDG22-112

MATERIAL LEGEND

6 I X 8 FASCIA BOARD W/ GUTTER

9 WOOD W/ STONE BASE COLUMN

10 ASPHALT ROOF SHINGLES

12 C-CHANNEL STEEL MEMBER

II GLASS GUARDRAILS

7 I X 6 ON I x 24 FASCIA BOARD W/

I STONE STYLE I

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PAINTED FINISH

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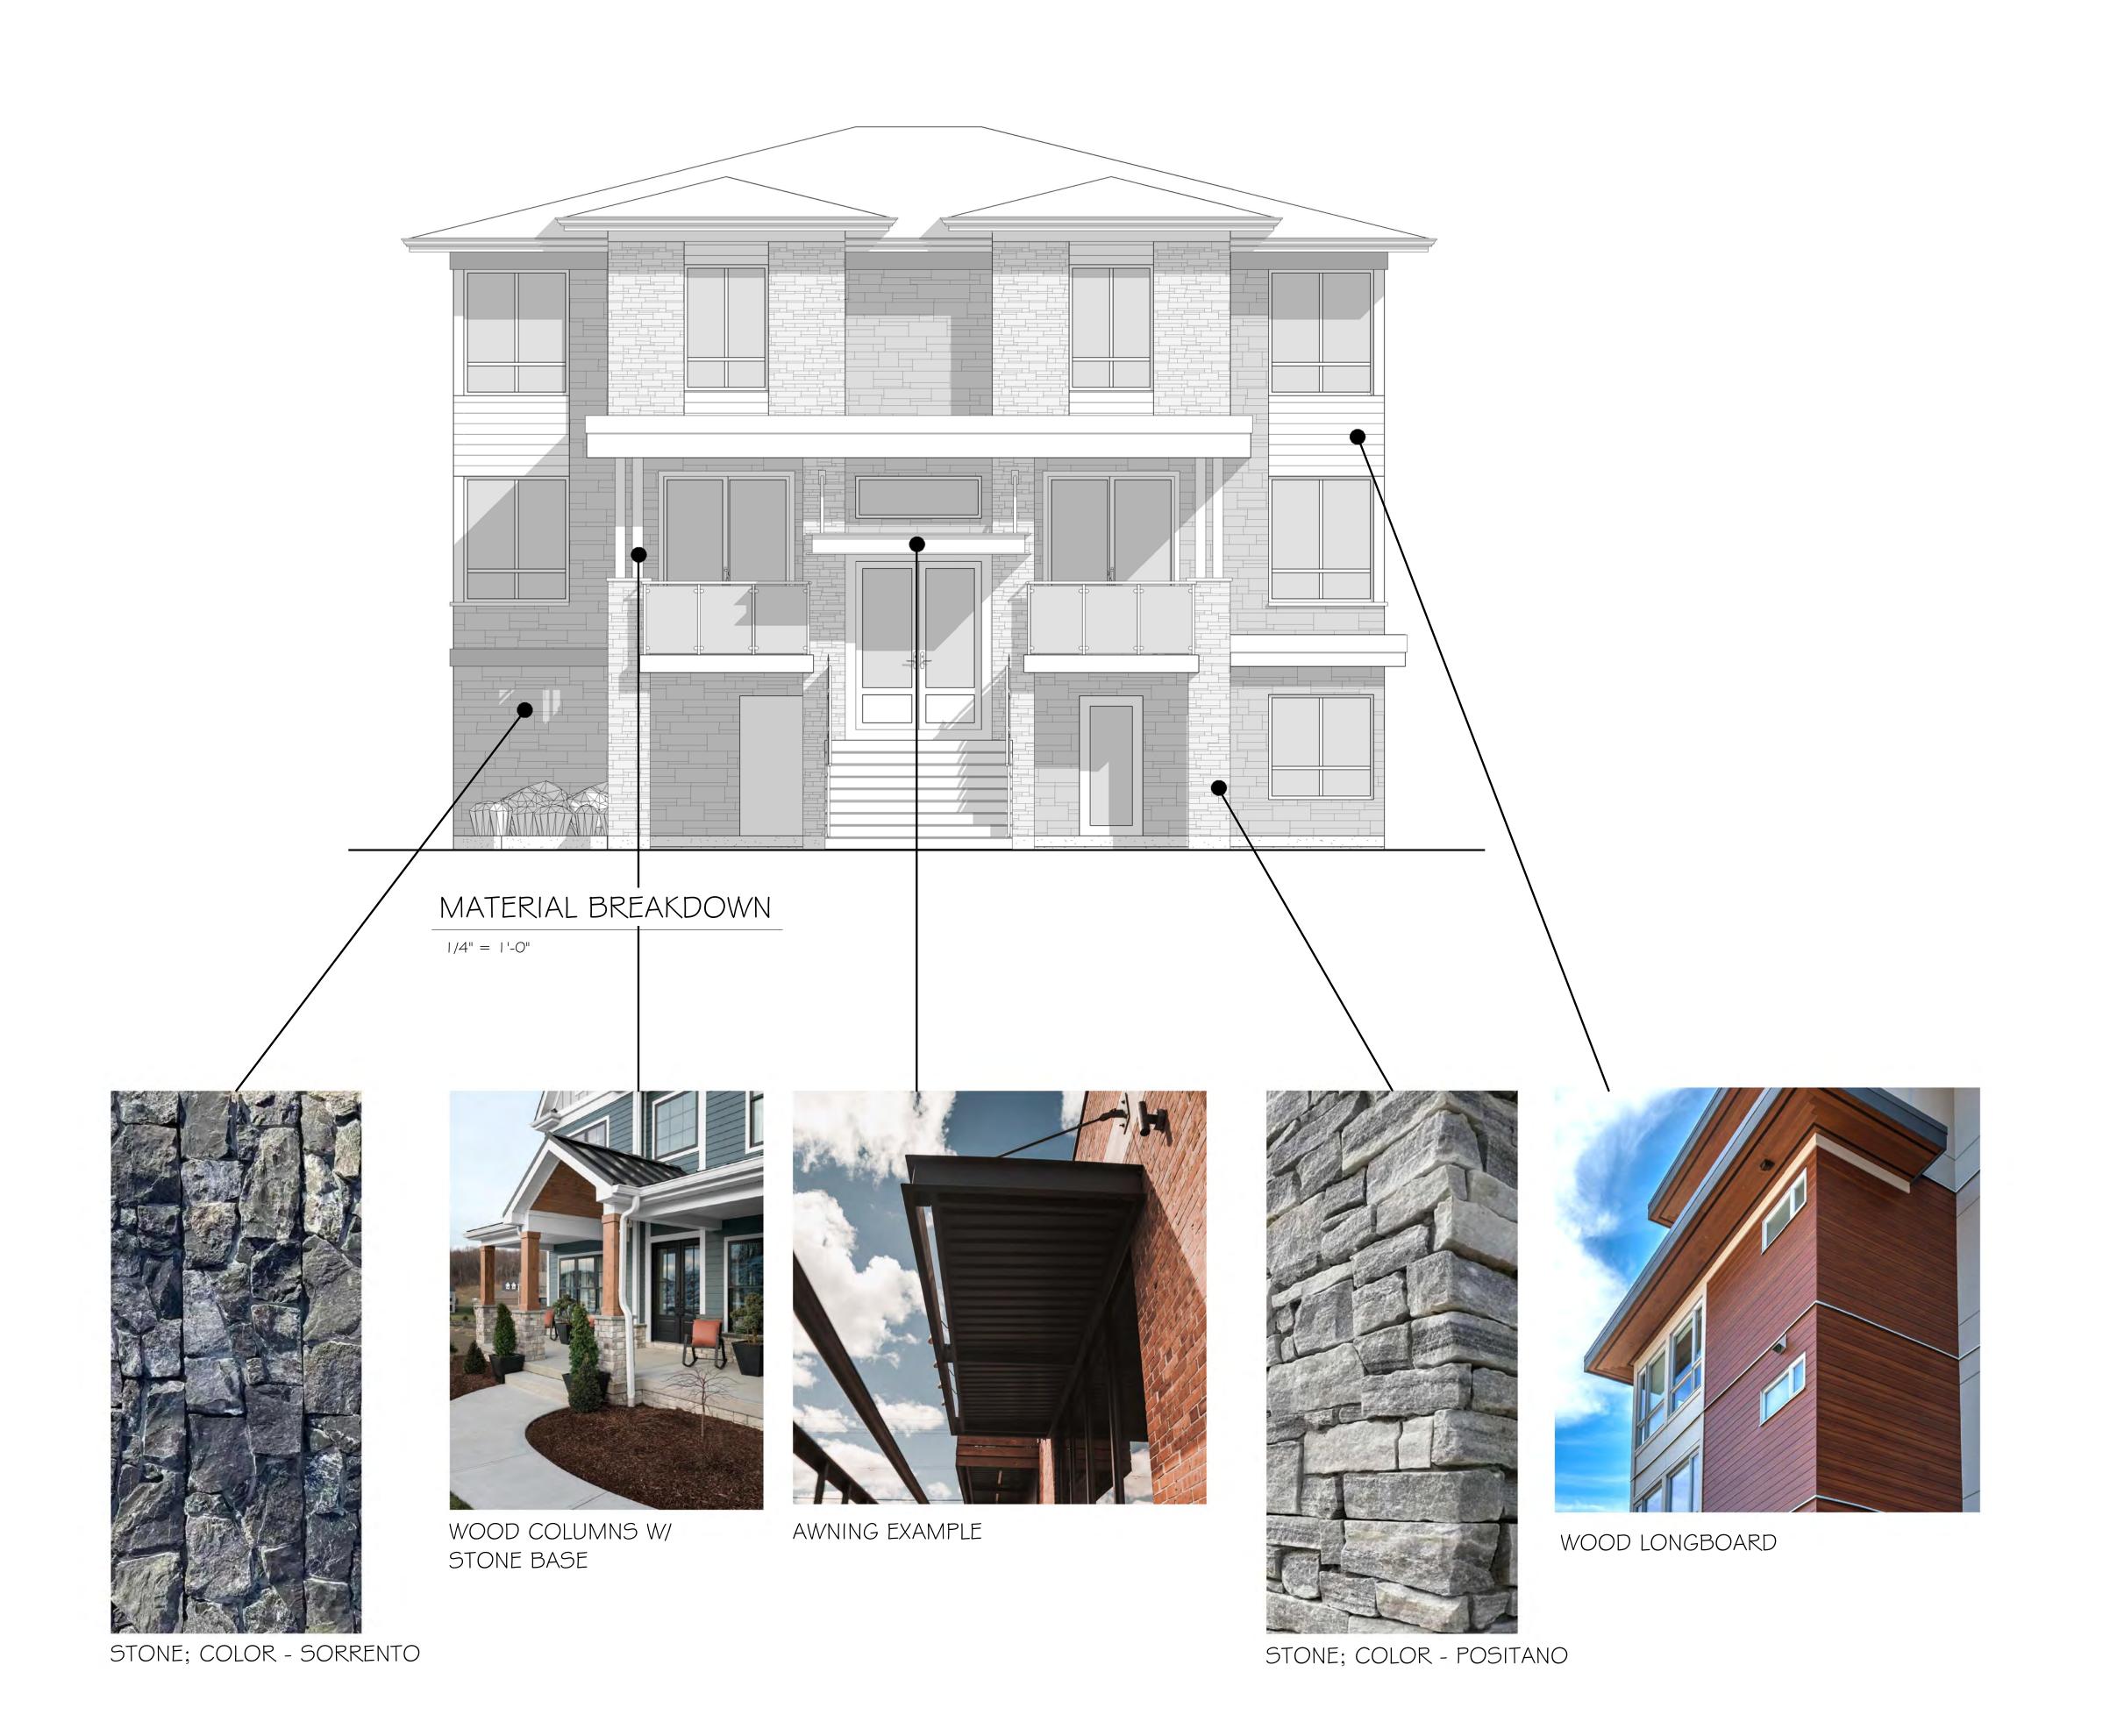
REAR & LEFT ELEVATIONS

ADDRESS:

5135 208A STREET LANGLEY

DRAWING:

A3.02





No.	Description	Date

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PROJECT NUMBER: MDG22-112

DRAWN BY: CHECKED BY:

RJ MB

DATE: SCALE:

DATE: SCALE: 1/4" = 1'-0"

SHEET TITLE:


MATERIAL BREAKDOWN

ADDRESS:

5135 208A STREET LANGLEY

DRAWING:

A3.03

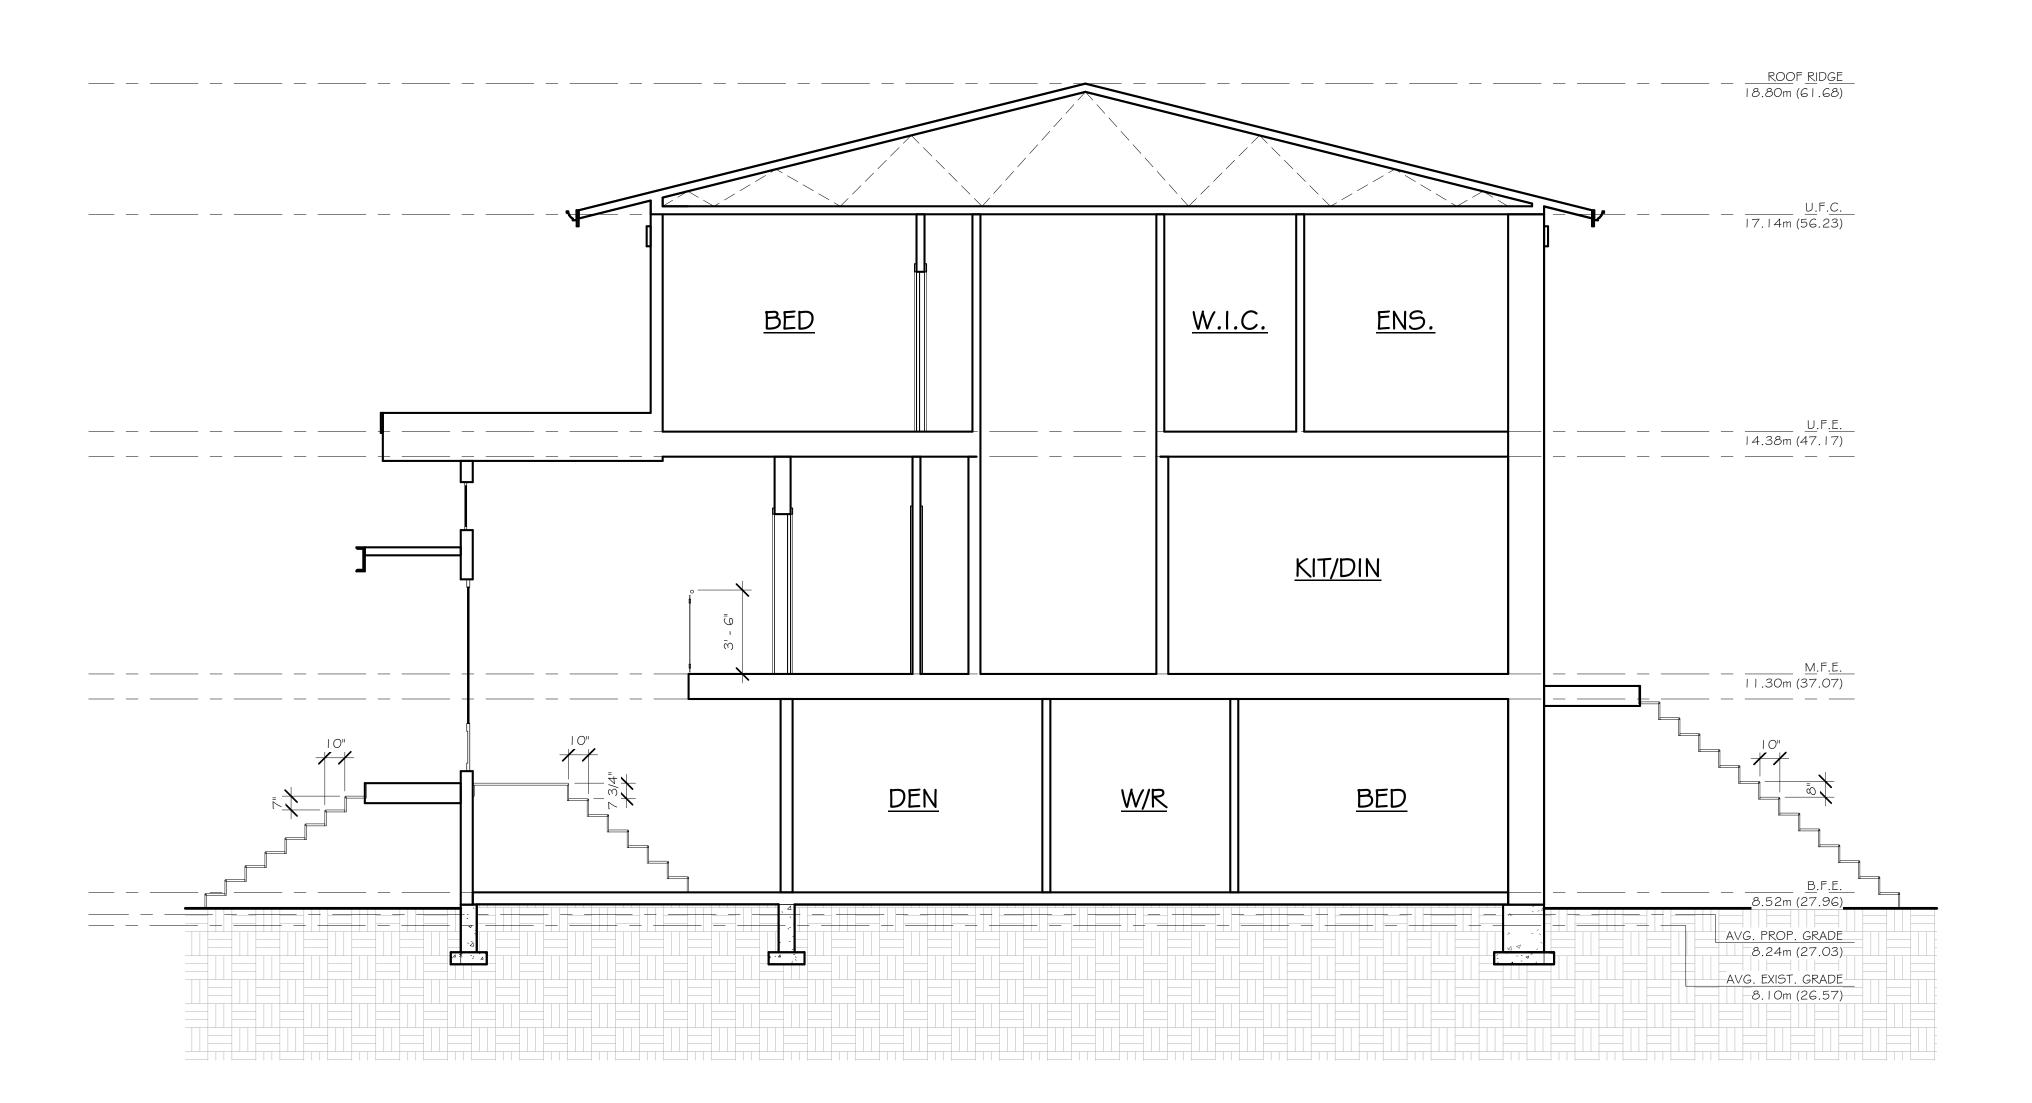

CROSS SECTION 'A'

1/4" = 1'-0"



UNIT #202-34654 DELAIR RD. ABBOTSFORD, B.C. V2S 2C9 TEL: (604) 217-9097 WWW.METHODDESIGNGROUP.COM

Description	Date
	Description

NOTES:

ALL DIMENSIONS TO BE CHECKED BY CONTRACTOR BEFORE START OF CONSTRUCTION & ANY DISCREPANCIES REPORTED.

THESE DRAWINGS CONFORM TO THE LATEST EDITION OF THE 2018 BRITISH COLUMBIA BUILDING CODE

PROJECT NUMBER: MDG22-112

DRAWN BY: CHECKED BY:
RJ MB
DATE: SCALE:

DATE: SCALE: 1/4" = 1'-0"

SHEET TITLE:

CROSS SECTION A

ADDRESS:

5135 208A STREET LANGLEY

DRAWING:

A4.01