

ADVISORY DESIGN PANEL

WEDNESDAY, NOVEMBER 22, 2023 AT 7:00 PM

Council Chambers Langley City Hall (In-Person Meeting)

AGENDA

1) AGENDA

Adoption of the November 22, 2023 agenda.

2) MINUTES

Adoption of minutes from the October 18, 2023 meeting.

3) DEVELOPMENT PERMIT APPLICATION DP 11-23

1,094 m² restaurant at 6141 200 Street.

4) **NEXT MEETING**

January 2024

5) <u>ADJOURNMENT</u>



MINUTES OF THE ADVISORY DESIGN PANEL

HELD IN COUNCIL CHAMBERS, LANGLEY CITY HALL

WEDNESDAY, OCTOBER 18, 2023 AT 7:01 PM

Present: Councillor Paul Albrecht (Chair)

Councillor Mike Solyom (Co-Chair)

Mayor Nathan Pachal

Matt Hassett Leslie Koole

Johnnie Kuo (7:05 pm)

Blair Arbuthnot Chad Neufeld Scott Thompson

Absent: Cst. Peter Mann

Tony Osborn Ella van Enter

Staff: C. Johannsen, Director of Development Services

A. Metalnikov, Planner

K. Kenney, Corporate Officer

Chair Albrecht began by acknowledging that the land on which we gather is on the traditional unceded territory of the Katzie, Kwantlen, Matsqui and Semiahmoo First Nations.

1) AGENDA

Adoption of the October 18, 2023 agenda.

It was MOVED and SECONDED

THAT the agenda for the October 18, 2023 Advisory Design Panel be approved.

CARRIED

Document Number: 190326

2) MINUTES

Adoption of minutes from the July 19, 2023 meeting.

It was MOVED and SECONDED

THAT the minutes of the July 19, 2023 Advisory Design Panel meeting be approved as circulated.

CARRIED

3) <u>DEVELOPMENT PERMIT APPLICATION DP 08-23</u> <u>ZONING BYLAW AMENDMENT APPLICATION RZ 07-23</u>

Proposed 6-storey, 136-unit apartment building at 20619 & 20629 Eastleigh Crescent.

Anton Metalnikov, Planner, spoke to the staff report dated October 6, 2023 and provided a brief overview of the Development Permit application.

Johnnie Kuo entered the meeting.

In response to questions from Panel members, staff advised that:

- The developer did not want to build a taller building due to financial factors, namely, the height limit for wood frame buildings is 6 stories, anything higher than that has to be a concrete building;
- The FAR is quite high for this development, and provides needed one bedroom units close to Kwantlen Polytechnic University;

The Applicant team entered the meeting:

Noel Lim, Project Manager, Keystone Architecture & Planning Ltd.

Andressa Linhares, Sr. Project Coordinator Design, Keystone Architecture & Planning Ltd.

Jennifer Wall, Landscape Architect/Project Manager, Keystone Architecture & Planning Ltd.

Steve Bartok, Principal, Keystone Architecture & Planning Ltd.

Mr. Lim presented the application, providing an overview of the development with details on the following:

- Project data
- Number of one, two, and three bedroom units
- Number of units that are adaptable
- Site description
- Other developments projects in the area
- Site plan

- Building amenities (indoor and outdoor)
- Unit storage
- Balcony orientation
- Garbage area
- Parking stalls
- Shadow studies

Ms. Linhares provided information on the building design and colours and Ms. Wall provided information on landscape design elements. Information was provided on the following:

- Connections to street and patios
- Size of patios
- Wall height
- Short term parking
- Offsite sodded tree lined pedestrian walkway
- Existing trees on the north with parkade set back from them
- Courtyard
- Paving patterns and materials
- Programming of the spaces
- Planters
- Amenity connection
- Covered BBQs, picnic tables, fire pit
- Sand play area
- Fenced in dog off leash area for small dogs
- Open area for play

It was noted that:

- They are bringing colour to the hardscape and landscaping to contrast the neutral building colour palette;
- They will have an aborist on site to ensure existing trees are protected during construction;
- The planters are getting 1 m soil volume and will provide buffers between units.

Panel members provided feedback on the form and character of the development and discussion took place regarding the following:

- Concerns with security of bike racks due to location and compatibility for electric bikes;
- Suggest filling in the gaps of the street trees;
- Accessibility concerns with sand surface; consider alternative surface for children's play area;
- Consider more quality fencing, more architecturally interesting;
- The three visitor parking stalls look like they will be difficult to get out of;
- Make sure ground units are well lit;

- Should look at reconfiguring the bike parking room entrance as it is currently accessed between two vehicle stalls;
- Concerns with parking configurations; some spots look difficult to get into;
- The stairs in the back are not clear on the drawings, review security;
- There are numerous outdoor amenity areas and they are all quire small; it might be better to have fewer but larger outdoor amenity areas;
- Suggest having a community garden if possible;
- The amenity space brown shades and materials are out of place with the rest of the development, suggest using colours to create more continuity;
- There are too many different materials distinguishing the different areas of the development;
- Choose to have the dog off leash area or the grassed area, not both;
- Consider more animation on the side where people go to park;
- The amount of amenity space is not enough for the number of units in the development;
- It's not clear what demographic this development is intended for; it does not appear to be designed for elderly people;
- The design of the double doors next to the elevator is confusing, it's not clear how people will exit that space to the outside amenity area and whether there is enough space; there could be safety issues;
- The colour of the building is rather bland; too many different materials being used given that they are all black;
- There isn't very much shade provided on the south side, consider more shading there;
- Recommend deconstruction not demolition of existing building on site;
- One of the seating areas could be removed to provide more space for other programming;
- For accessibility purposes doors for both indoor and outdoor amenity spaces should have automatic functionality;
- Should design the appliances in the adaptable units such that they can be made adaptable in the future;
- Implement additional noise attenuation measures for units next to the elevator and those with a bedroom wall that is shared with their neighbouring unit's living room;
- Suggest using Canada Post standard mail room equipment as they are more secure and durable;
- Consider having a bike maintenance room with automatic door to the room;
- Incorporate wood element to give warmer, friendly felling to chain link fence;
- Break up the monotony of the wall on the lane by adding a treatment with more visual appeal;

In response to questions from Panel members, the applicant team advised that:

- The surface material for the off-leash dog area will be mulch or pea gravel;
- In order to address potential issues with maneuverability of visitor parking spots they will look at a larger turnaround;
- There will be opaque privacy screens between the walk up patios;
- All units on ground floor have gates;
- The courtyard will have lighting;
- The reason they included an off-leash dog was there is nowhere near for people with pets to go, but they can discuss with client about where they could possibly reduce some outdoor amenity uses;
- They are trying to include edibles in the plantings on site; the podium area is too shady for a communal garden;
- It is a solid, four foot high wall on the lane where the parking stalls are, but is open above; the lane is lower;
- The loading parking space is accessed from the lane; and is also accessible from accessible entrance ramp; the podium level is accessible from the loading parking space;
- The development will be market housing;
- They can discuss the possibility of installing air conditioning/ heat pumps with the owner;
- Storage lockers will be included with each unit;
- They haven't yet discussed providing electrical plugs in the bike storage area for e-bikes;
- The strata will be responsible for maintaining the sand pit;
- Use Canada post mailboxes, more secure and durable;
- The roof treatment will be reflective to reduce heat island effect;
- There isn't a sidewalk on the lane; however, there is a planter there;
- Given that the fire pit could be an ongoing liability; suggest removing that amenity to provide more space for other amenities;

The applicant team left the meeting.

In response to questions from Panel members, staff advised that:

- With respect to having boulevard ground cover that is easy to maintain and discourages use of these areas as places for dogs to do their business:
 - o another development project did look at different possibilities;
 - o staff will discuss the issue with Engineering staff:
 - in new areas in Vancouver, boulevards have been converted to turf; staff are not suggesting this approach;
- Staff can determine if it is feasible to have an amenity space on the roof;
- Barriers cannot put between the stalls that are on either side of the entrance to bike parking room as cars wouldn't be able to maneuver into those stalls:
- There will also be laneway access for the development under construction at Glover Rd. and Eastleigh Crescent;

• The City does permit fire pits in developments; however, the Fire Department does have some requirements.

The Panel compiled a list of recommendations for the applicant.

It was MOVED and SECONDED

THAT:

- 1. The ADP receive the staff report dated October 6, 2023 for information; and
- 2. The ADP recommends the applicant give further consideration to the following prior to the application proceeding to Council:
 - a. Ensure secure model of visitor bicycle rack is used (e.g. two lock point potential) and improve visibility of visitor bike racks from within building (e.g. bringing them onto podium level);
 - b. Review opportunity for additional street-fronting trees on site;
 - c. Use an alternative fence material to chain link around the dog run area, including considering wood elements;
 - d. Review maneuverability of parking areas, including visitor parking spaces and bicycle room access between parking spaces;
 - e. Review use of sand in children's play area for accessibility and consider an alternative surface;
 - f. Consider reconfiguring the outdoor amenity area with fewer but larger programmed areas and simplifying the material palette;
 - g. Consider providing communal garden plots and/or edible plantings;
 - h. Consider more closely aligning colour palettes between building cladding and landscape materials;
 - i. Provide more design interest to the west parkade wall;
 - j. Review location of loading zone for usability;
 - k. Consider providing a rooftop amenity area;
 - Review Building Code compliance of courtyard exiting and elevator lobby;
 - m. Consider opportunities for shading on south-facing units;
 - n. Provide automatic doors for amenity spaces, both indoor and outdoor, and bicycle rooms;
 - Review accessibility of appliances in adaptable units (e.g. washers & dryers);
 - Consider the use of electric building systems (e.g. heat pumps and/or air conditioning);
 - q. Consider additional sound attenuation measures for units with elevator
 & living room-to-bedroom wall interfaces;
 - r. Provide electrical connections in bicycle rooms for e-bikes;
 - s. Consider providing a bicycle maintenance area;
 - t. Review and ensure security of the rear courtyard exit stair;

<u>CARRIED</u>

4) <u>DEVELOPMENT PERMIT APPLICATION DP 08-22</u> ZONING BYLAW AMENDMENT APPLICATION RZ 05-22

Proposed 14-unit townhome complex at 4503 & 4513 200 Street.

Anton Metalnikov, Planner, spoke to the staff report dated October 4, 2023 and provided a brief overview of the Development Permit application.

Carl Johannsen, Director of Development Services advised that staff have proof of concept that other properties surrounding this development are viable for similar development; noting there are a number of ways to have access to the sites.

In response to questions from Panel members, staff advised that:

- The strata for this development will be made aware of the fact that the temporary lane being built will be closed in the future through information provided in signage on the site, in any sale documents and in a covenant placed on title;
- Once the lane is closed (which will occur only after neighbouring properties are developed), there are a number of options to prevent people from using it, which staff can discuss with Engineering staff;
- The temporary lane is not required to be a fire access; however, the Fire Department may want to have that option;
 - the moratorium on rezoning properties south of 50th Avenue Council imposed last year has been lifted as staff fulfilled the requirements Council requested be undertaken including such things as conducting a community survey of residents in the area and developing a best practices guide for ground-oriented residential developments in this area;
- No formal development applications have been received to date for the property to the north; however, the OCP does allow for redevelopment mid-block.
- The lane at the back will be constructed for this development and when the property to the north is developed, they will do the same;
- The lane will be dedicated as part of this development;
- The property to the south will have a hammerhead turn-around
- There will be a fence along the boundary of the property to the south;
- A traffic study will be undertaken for the intersection to the north; the
 potential to exit onto 200 St. and turn left will be reviewed as part of the
 traffic study;
- This building is three stories which is the maximum height for buildings in this area under the OCP:
- Staff will ask the applicant to correct the renderings that currently show the property backing onto a park, as it will actually be backing onto the fence of a single family home;
- The lane is 8 m wide; the building is 10 to 11 m away from property line of a single family home; on 200 Street there will be separation between

the traffic lane and pedestrian corridor, though there may be some sidewalk portions near the street in order to protect existing trees.

The Applicant team entered the meeting:

Layne French, Applicant

Meredith Mitchell, Landscape Architect, M2 Landscape Architecture Fred Adab, Architect, F. Adab Architects Inc.

Azar Ahmadi, Senior Designer, Associate, F. Adab Architects Inc.

Mr. Adab presented the application, providing an overview of the development with details on the following:

- Context Plan
- Aerial Map
- Site Plan
- Energy savings and green measures
- Exterior finishes and colour
- First, second and third floor plans
- CPTED measures

Ms. Mitchell provided information on landscape design elements:

- Some retained trees on site
- Paving
- Pedestrian walkway
- Individual walkways to units
- Buffer planting between semi- public and public to private patio spaces
- Green planting at internal road
- Two units next to 200 St. stepped back to create front yard in keeping with other houses on street.

Panel members provided feedback on the form and character of the development and discussion took place regarding the following:

- When the lane is to be closed off make it more attractive by using fencing or landscaping to close it off rather than bollards;
- Adding some architectural interest to the blank wall;
- Include more wood in the development, including possibly on the front blank wall;

Councillor Solyom left the meeting at 9:15 pm. and did not return to the meeting.

- Possibility of adding solar panels, or pre-wiring for it in the future; engage with energy advisor;
- Height of the street fronting façade is quite big compared to single family, try to break up plane;
- There is not a lot of room for storm water retention; change to less impermeable surfaces;

Shading is needed on south facades and would add interest;

- Adding rain shelter for decks on north side would make them for usable;
- Suggest using different surfaces in the lane to define vehicle and pedestrian access areas;
- As patios are so small, lane will become amenity space used by pedestrians, accordingly, support this use by having a surface treatment other than asphalt for the lane;
- Backyards are almost unusable; consider flipping building design to give extra space on drive aisle or planting areas, have front door on garage side;
- Create a physical buffer between visitor parking and buildings;
- The pavers between the sidewalk and centre laneway, there is the opportunity to run more texture down the centre or at least past the green space;
- Suggest charcoal brick instead of hardy board for the gable ends;
- There is an opportunity to mirror the buildings;
- Recommend broader flashing around windows;
- If using hardy board for the gable ends make it horizontal instead of vertical;
- Ensure the lighting in the development is down lighting so as not to impact neighbouring single detached homes;
- Need to delineate sidewalk in lane with curbing or vertical element to prevent vehicles from parking on it;
- Possibility of having garage doors with pedestrian door;
- Include unit numbers on garage doors for first responders and delivery drivers;
- Consult with owners of single family lots neighbouring the property as to what type of fencing they would be amenable to;
- Show room configuration of the smallest bedroom.

In response to questions from Panel members, the applicant team advised that:

- In the backyards there is a 1 m planting and walkway, planting bed, and 2 x 2 paver-covered area; there will be a small space that could accommodate a BBQ:
- The patio is 6 x 14 ft.; they could make the patio bigger but they wanted to have planting space to create separation from the walkway and patio;
- The hedge is inside the fence;
- There will be white magnolias, and conifer fir trees in front of the blank centre wall;
- The planting on the driveway will be viable;
- The intention is for garbage to be picked up from individual units;
- They can look at making the yards greener;
- There are privacy screens between balconies;
- They have not considered extra noise attenuation for units facing 200
 Street, but could hire sound acoustical consultant

- The powder rooms are fully within the units;
- The condenser, fresh air intake, and exhaust for the heat pump are all in the garage;
- Bedroom placement below kitchen is normal, additional fire safety measures are put in place;
- The building will have sprinklers.

In response to questions from Panel members, staff advised that:

- The OCP and ground-oriented development guidelines indicate that yards need to be 4.5 m deep;
- The unit threshold to require amenity space be built in a development is 20 units:
- There is a park nearby to this development;
- City regulations require 4.5 m setbacks with the key goal of achieving 9
 m separation distances between building faces; while a secondary goal
 is for these setbacks to create larger yards, given the significant
 dedications on this project, front doors were located along private
 walkways to maintain a typical townhome unit density which resulted in
 smaller back yards;
- Staff can get clarification on what kind of heat pump is being used before this application comes back to Council;
- Staff will review building guidelines to determine if wood fences are permitted. (It was subsequently noted by a Panel member that wood may not be the best material to use for the long term);

The applicant team left the meeting.

The Panel compiled a list of recommendations for the applicant.

It was MOVED and SECONDED

THAT:

- 3. The ADP receive the staff report dated October 6, 2023 for information; and
- 4. The ADP recommends the applicant give further consideration to the following prior to the application proceeding to Council:
 - a. Update renderings to illustrate accurate design and context (landscaping, balcony dividers);
 - b. Require an update to the street-fronting façade to better engage 200 Street, especially in central white space, including to bring down the apparent height (e.g. greater use of wood, brick, blue accent colours, considering window ornamentation, horizontal breaks);
 - c. Consider solar panels on roof (installed or pre-wired);
 - d. Consider more depth articulation to break up the block volumes;

- e. Review shading features on south-facing elevation and rain shelter on north (consider blue accents), including consulting with an energy advisor;
- f. Update surface materials in the central lane for place-making and to demarcate vehicle and pedestrian space;
- g. Provide protection between visitor parking spaces and buildings;
- h. Update landscape plans to remove garbage enclosure notation;
- i. Consider a broader window flashing;
- j. Ensure lighting design does not create a nuisance for neighbouring properties;
- k. Consider measures to improve the durability of the in-lane landscaping;
- I. Update the lane sidewalk to include a curb, while maintaining single slab design for Fire Rescue access;
- m. Consider garage doors with integrated person-doors and include unit addressing and wayfinding in internal lane;
- n. Replace wood fencing with a more durable material, including communication with neighbours;
- o. Provide more information on heat pump equipment configuration and location;
- p. Provide a sample room layout in the smallest bedroom;
- q. Provide enhanced sound attenuation measures on 200 Street-facing units.

<u>CARRIED</u>

5) **NEXT MEETING**

November 8, 15, or 22

6) ADJOURNMENT

It was MOVED and SECONDED

THAT the meeting adjourn at 9:48 pm.

CARRIED

ADVISORY DESIGN PANEL CHAIR

CORPORATE OFFICER

P. alhalt



ADVISORY DESIGN PANEL REPORT

To: Advisory Design Panel

Subject: **Development Permit Application DP 11-23**

(6141 200 Street)

From: Anton Metalnikov, RPP, MCIP File #: 6620.00

Planner Doc #:

Date: November 15, 2023

RECOMMENDATION:

THAT this report be received for information.

PURPOSE OF REPORT:

To consider a Development Permit application by Valley Properties Ltd. for the development of a 1,094 m² restaurant at 6141 200 Street.

A previous Development Permit application (DP 04-22) for the same location and use was reviewed by the Advisory Design Panel on June 22, 2022 and approved by Langley City Council on October 24, 2022. Due to a new proposed design that reflects the end user's updated corporate branding, a new Development Permit application is required. However, because this new application primarily consists of exterior design-related changes to the previous application while generally maintaining the previous site layout and building configuration, an abridged report is provided to outline these proposed changes, with the original report attached separately for background information and context.

Subject: Development Permit Application DP 11-23

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POLICY:

The subject property is currently zoned C2 Service Commercial in Zoning Bylaw No. 2100 and designated "Service Commercial" in the Official Community Plan (OCP) Land Use Map. All lands designated for commercial uses are subject to a Development Permit (DP) to address building form and character.

COMMENTS/ANALYSIS:

Background Information:

Applicant & Owner: Valley Properties Ltd. **Civic Address:** 6141 200 Street

Legal Description: Lot B, Section 10, Township 8, New

Westminster District, Plan 84272

Site Area: 4.7 hectares (11.7 acres) **Gross Floor Area (CRU):** 1,094.35 m² (11,779.6 ft²)

Floor Area Ratio (Total): 0.23 Lot Coverage (Total): 23%

Total Parking Required 352 spaces (including 18 h/c spaces)

(Full Property)

Total Parking Provided 637 spaces (including 18 h/c spaces)

(Full Property):

Parking Required 35 spaces (including 2 h/c spaces)

(Restaurant Only):

Parking Provided 72 spaces (including 3 h/c spaces)

(Near Restaurant):

OCP Designation: Service Commercial **Zoning:** C2 Service Commercial

Development Cost Charges: \$89,272.65 (City - \$29,170.08, GVS&DD -

\$14,087.70, GVWD - \$40,635.93,

TransLink - \$5,378.94)*

*DCCs noted are in addition to those paid by the applicant for the previous design

Discussion:

1. Design

The applicant has submitted this new design proposal as a result of branding updates made by the intended user, King Taps restaurant. As a new restaurant chain with two locations at this time, the company's branding has continued to be in development since the original application was made. The applicant has now decided to update the

Subject: Development Permit Application DP 11-23

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design of the proposed restaurant to align with this more recent branding, particularly due to this being King Taps' first standalone building. The Red Robin restaurant which had existed on the subject site has been demolished in preparation for the construction of the new proposed restaurant.

The main change in the new design is the replacement of the original material palette with one based primarily on GFRC (glass-fibre reinforced concrete) panels, with glazing and wood-tone soffits and details. The concrete panels are provided in both smooth and raked textures, with concrete breeze blocks also provided as a semi-permeable screen near the main entrance, the seasonal outdoor patio, and around the rooftop mechanical equipment. The applicant has noted the concrete panels will be treated with a protective graffiti-resistant coating.

The new design also adds a second storey on the north end of the building for a staff area. This additional storey brings fenestration further up the building's 200 Street façade, while generally maintaining the height of the original proposal which included rooftop equipment screening at a similar height as the new roof line. On the single-storey portion of the building, the new design's lower-height concrete breeze block screening contributes to a tiered massing that steps down from north to south. This updated form also includes an enlarged all-season patio with sliding glass windows which reduces the apparent length of the overall structure.

The landscaping was also modified to align with the building redesign. This included providing two fewer new trees than originally proposed due to the reconfiguration of the entry area and the all-season patio, while still providing five new trees for a net increase of two trees over the current number. The new proposal also adds a retention pond, encircled with various grass and shrub species, near the building's southeast.

2. Summary:

The application is consistent with the site's zoning and OCP designation and policies. It updates a previously-approved proposal on the site primarily to employ a concrete panel-based material palette.

Advisory Design Panel:

Advisory Design Panel: In accordance with Development Application Procedures Bylaw No. 2488, the subject DP application will be reviewed by the Advisory Design Panel (ADP) at the November 22, 2023 meeting. According to the Council-approved ADP Terms of Reference, the ADP is to provide form and character and urban design-related advice and recommendations for Council's consideration. ADP advice and recommendations will be presented to Council through the ADP meeting minutes and

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an additional City staff report prior to Council consideration of the proposed applications. A copy of the ADP minutes will be presented to Langley City Council at a future Regular Council meeting.

BUDGET IMPLICATIONS:

In accordance with Bylaw No. 2482, the proposed development would contribute \$29,170.08 to City Development Cost Charge accounts

Prepared by:

Anton Metalnikov, RPP, MCIP

Planner

Concurrence:

Roy M. Beddow, RPP, MCIP

Deputy Director of Development Services

Concurrence:

Carl Johannsen, RPP, MCIP

Director of Development Services

Attachments

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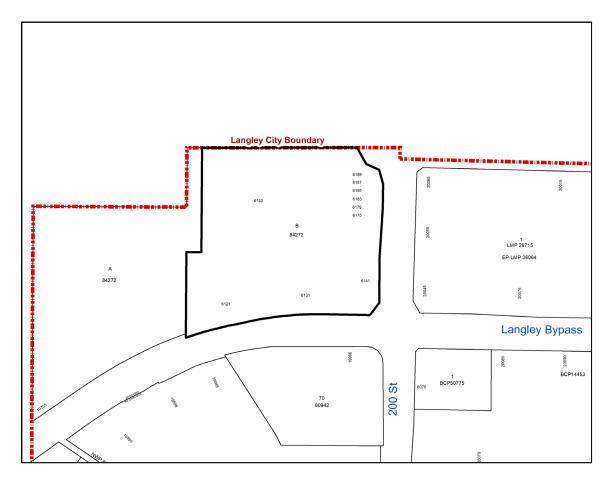
DEVELOPMENT PERMIT APPLICATION DP 11-23

Civic Address: 6141 200 Street

Legal Description: Lot B, Section 10, Township 8, New Westminster District,

Plan 84272

Applicant & Owner: Valley Properties Ltd.





Advisory Design Panel Report

To: Advisory Design Panel

Subject: Development Permit Application DP 04-22

(6141 200 Street)

From: Anton Metalnikov, RPP, MCIP File #: 6620.00

Planner Doc #:

Date: April 14, 2022

RECOMMENDATION:

THAT this report be received for information.

PURPOSE OF REPORT:

To consider a Development Permit application by Randy Olafson for the development of a 746 m² restaurant at 6141 200 Street.

*This report has been updated to note progress on outstanding engineering requirements (see Page 8).

POLICY:

The subject property is currently zoned C2 Service Commercial in Zoning Bylaw No. 2100 and designated "Service Commercial" in the Official Community Plan (OCP) Land Use Map. All lands designated for commercial uses are subject to a Development Permit (DP) to address building form and character.



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COMMENTS/ANALYSIS:

Background Information:

Applicant: Randy Olafson

Owner: Valley Properties Ltd. Civic Address: 6141 200 Street

Legal Description: Lot B, Section 10, Township 8, New

Westminster District, Plan 84272

Site Area: 4.7 hectares (11.7 acres) **Gross Floor Area (CRU):** 746.33 m² (8,033.46 ft²)

Floor Area Ratio (Total): 0.22 Lot Coverage (Total): 22%

Total Parking Required 342 spaces (including 17 h/c spaces)

(Full Property)

Total Parking Provided 637 spaces (including 17 h/c spaces)

(Full Property):

Parking Required 24 spaces (including 2 h/c spaces)

(Restaurant Only):

Parking Provided 55 spaces (including 2 h/c spaces)

(Near Restaurant):

OCP Designation: Service Commercial **Zoning:** C2 Service Commercial

Development Cost Charges: \$17,909.52 (City - \$11,370.04, GVS&DD -

\$4,442.85, TransLink - \$2,096.63)

Discussion:

1. Context

The applicant is proposing to demolish an existing Red Robin restaurant on the southeast corner of the Willowbrook Park shopping complex (6141 200 Street) and replace it with a new King Taps restaurant 746.33 m² in size. This development is proposed on a single large commercial property which currently hosts five buildings (including that proposed for redevelopment) among an expansive surface parking area. Within this context, the new restaurant would contribute to a Floor Area Ratio (FAR) of 0.22 on the overall property and share the total parking supply with the other buildings on it, with its immediate area hosting over double the number of parking spaces (55) than would be required if the restaurant was located on its own property (24). The proposed new restaurant building complies with the property's existing C2 Service Commercial zoning, which aligns with its Service Commercial designation in the City's OCP.

The property is located in a major highway-oriented commercial area and is surrounded by other large commercial complexes, including the Willowbrook



Subject: Development Permit Application DP 04-22

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Shopping Centre to its west and the Township of Langley portion of Willowbrook Park to its north. To the east and south, the property is bounded by 200 Street and the Langley Bypass, both of which, in this area, are major Provincial Ministry of Transportation and Infrastructure (MOTI)-owned roads that separate the property from the Langley Centre shopping complex and an automotive dealership respectively. The actual redevelopment site consists of a single existing building on the far southeast corner of the property.



Site Context

2. Design

The new restaurant is proposed at the same location and in a similar configuration as that which it will replace, but at a greater size which will accommodate both a larger building as well as two patio spaces to the south on land currently used for parking. The patio closer to the building will be semi-enclosed, while that further south toward the Langley Bypass is proposed as an open concrete pad which can be programmed with movable furniture as weather permits. The new restaurant will result in a minor rearrangement of the space



Subject: Development Permit Application DP 04-22

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around it, and is oriented to address the property's two fronting streets while screening its parking lot and showcasing its expansive landscaped area.

The development's design takes a modern west coast aesthetic through the use of simple lines and a natural colour palette featuring materials such as wood, brick, glass, and aluminum. The entrance is accessed from the building's primary frontage on the west, through a prominent covered entryway leading to a generously-glazed dining room. The patio spaces are aligned with this direction as well while also opening up to the south street frontage. On the north façade, the building's service functions are accommodated through a simplified design which continues around the corner along the east where it opens up the kitchen area inside to the 200 Street frontage through large windows.

The proposed landscape design maintains the existing lush planting area between the building and the 200 Street sidewalk as well as the existing grass lawn at the southeast corner wrapping along the Langley Bypass. As a result of the parking area reconfiguration, additional green space has also been provided through a wide variety of shrubs and grasses punctuated by seven new trees, including one in the centre of the semi-enclosed patio. The updated landscaping also allows for three new walkway connections to be made to the 200 Street sidewalk and its intersection with the Langley Bypass, which improves pedestrian access not only to the restaurant but the other existing commercial buildings beyond it on the property as well.

These walkway connections support accessibility into the site, which is further incorporated into the development through a curb letdown connecting two immediately adjacent accessible parking stalls to the main entrance.

3. Sustainability

The proposal incorporates several sustainable development features including:

- Using construction techniques that minimize site disturbance and protect air quality;
- Incorporating recycled building materials;
- Achieving an energy performance of 25% better than the current Model National Energy Code;
- Using a Heat Recovery Ventilator (HRV) system;
- Making use of a reflective roof to reduce the heat island effect;
- Incorporating an irrigation system with central control and rain sensors;
- Using ultra-low flush toilets;
- Replacing a surface parking area with usable space and landscaping;
- Providing a staff bike parking area and outdoor customer bike rack;
- Improving pedestrian connectivity between the property and the City sidewalk network; and



Subject: Development Permit Application DP 04-22

Page 5

• Providing two parking stalls with electric vehicle (EV) chargers.

4. CPTED

The proposal benefited from a Crime Prevention Through Environmental Design (CPTED) review, with its recommendations incorporated either in the development permit plans or in subsequent the building permit submission.

5. Summary

This application is consistent with the property's zoning and OCP designation and policies. The proposed redevelopment would update an existing restaurant located directly on the corner of 200 Street and the Langley Bypass and strengthen this area of the City as a key regional commercial destination.

Engineering Requirements:

Additional design changes may be required upon further investigation, site inspections and receipt of other supporting reports and documents.

All work to be done to the City of Langley's <u>Design Criteria Manual</u> (DCM), and the City's <u>Subdivision and Development Servicing Bylaw</u> (SDSB).

Per the City's DCM requirement, the developer and their consulting engineer shall submit to the City Engineer a signed and sealed copy of Form F-1 (Commitment by Owner and Consulting Engineer) prior to starting their design works.

Per the City's Watercourse Protection Bylaw No. 3152, the developer's consulting engineer shall submit to the City Engineer a signed and sealed copy of Form F-1 (Confirmation of Commitment by Qualified Environmental Professional - QEP) prior to starting their site monitoring works.

These requirements have been issued to reflect the application for development for a proposed **Restaurant Re-Development located at 6141 200 Street**.

These requirements may be subject to change upon receipt of a development application.

The City's Zoning Bylaw, 1996, No. 2100 has requirements concerning landscaping for buffer zonings, parking and loading areas, and garbage and recycling containers, all of which applies to this design.



Subject: Development Permit Application DP 04-22

Page 6

A) The developer is responsible for the following work which shall be designed by a Professional Engineer:

- A Qualified Environmental Professional (QEP) must be engaged to implement erosion and sediment control in accordance with the City of Langley Watercourse Protection Bylaw #3152, as amended.
- II. New water and sanitary sewer service connections to the property are required. All pertinent pipe design calculations shall be submitted in spreadsheet format and shall include all formulas for review by the City. The Developer's engineer will determine the appropriate main tie-in locations and size the connections for the necessary capacity.
- III. The capacity of the existing water and sanitary sewer mains require assessment through hydraulic modeling performed by the City's hydraulic modeling consultant at the Developer's expense.
 - a. Any upgrade requirement for either sanitary or water mains not covered under the City's DCC bylaw shall be designed and installed by the Developer at the Developer's expense.
 - b. At the Developer's expense, the City's hydraulic modeling consultant shall conduct a fire hydrant flow test to be used in the City's water modeling to determine if the existing water network is adequate for fire flows (based on architectural data supplied by the Developer's Architect). Upgrading of the existing watermain(s) may be necessary to achieve the necessary pressure and flows to conform to Fire Underwriters Survey (FUS) "Water Supply for a Public Fire Protection, a Guide to Recommended Practice, 1995."
- IV. Additional C71P fire hydrants may be required to meet bylaw and firefighting requirements. Hydrant locations must be approved by the City of Langley Fire Rescue Service.
- V. The site layout shall be designed by a civil engineer to ensure that the parking and access layout meets minimum design standards, including setbacks from property lines. Appropriate turning templates should be used to prove parking stalls and drive-aisles are accessible by the design vehicle.

B) The Developer is required to deposit the following bonding and fees:

- I. The City will require inspection and administration fees based on a percentage of the estimated construction costs, as per the City's Subdivision and Development Servicing Bylaw 2021 #3126.
- II. A deposit for a storm, sanitary and water services is required, which will be determined by City staff after detailed civil engineering drawings are submitted, sealed by a Professional Engineer.



Subject: Development Permit Application DP 04-22

Page 7

- III. The City will require a \$40,000 bond for the installation of a water meter to current City standards as per the DCM.
- IV. A signed and sealed pavement cut form (Form F-2 of the City's DCM) shall be completed by the developer's consulting engineer. Upon the review and approval of the City Engineer of the submitted form, the corresponding Permanent pavement cut reinstatement and degradation fees shall be paid by the Developer.

NOTE: Deposits for utility services or connections are estimates only. The actual cost incurred for the work will be charged. The City will provide the developer with an estimate of connections costs, and the Developer will declare in writing that the estimate is acceptable.

C) The Developer is required to adhere to the following conditions:

- 1. Unless otherwise specified by the City Engineer, all engineering works shall be designed based on the City's DCM specifications in accordance with the City's Subdivision and Development Servicing Bylaw 2021, No. 3126
- 2. Transformers servicing developments are to be located on private property with maintenance access located on private property. All transformers to be wrapped upon installation by the Developer.
- 3. All survey costs and registration of documents with the Land Titles Office are the responsibility of the developer/owner. Please refer to the City's Subdivision and Development Servicing Bylaw 2021, No. 3126 for more details.
- 4. A water meter is required to be installed in the mechanical room, in accordance to the City's DCM standards at the Developer's cost.
- 5. An approved backflow prevention assembly must be installed on the domestic water connection immediately upon entering the building to provide premise isolation.
- 6. A City approved oil and grit separator is required to treat site surface drainage.
- 7. Digital drawing files in *.pdf* and *.dwg* formats shall be submitted. All the drawing submissions shall:
 - a. Use City's General Note Sheet and Title Block; and
 - b. Closely follow the format and sequence outlined in the City's DCM that will be provided to the Developer's Consulting Engineer.
- 8. Garbage and recycling enclosures shall accommodate on the site and be designed to meet Metro Vancouver's "Technical Specifications for Recycling and Garbage Amenities in Multi-family and Commercial Developments - June 2015 Update." Please refer to the City's



Subject: Development Permit Application DP 04-22

Page 8

Subdivision and Development Servicing Bylaw 2021, No. 3126 for more details.

*Following review of the recent civil engineering design submission, City staff have advised the applicant of a cash-in-lieu contribution towards a water service upgrade for the property. The applicant will be required to provide the contribution and complete any other outstanding requirements prior to DP issuance.

Fire Department Comments:

Fire department access for the whole project was reviewed to ensure adequate access was in place to accommodate fire apparatus and personnel. A construction fire safety plan may also be required for this project. Fire suppression will be coordinated at the Building Permit stage including sprinkler systems and FDC locations.

Advisory Design Panel:

In accordance with Development Application Procedures Bylaw No. 2488, the subject DP application will be reviewed by the Advisory Design Panel (ADP) at the June 22, 2022 meeting.

According to the Council-approved ADP Terms of Reference, the ADP is to provide form and character and urban design-related advice and recommendations for Council's consideration. ADP advice and recommendations will be presented to Council through the ADP meeting minutes and an additional City staff report prior to Council consideration of the proposed applications.

A copy of the ADP minutes will be presented to Langley City Council at a future Regular Council meeting.

BUDGET IMPLICATIONS:

In accordance with Bylaw No. 2482, the proposed development would contribute \$11,370.04 to City Development Cost Charge accounts.



Subject: Development Permit Application DP 04-22

Page 9

Prepared by:

Anton Metalnikov, RPP, MCIP Planner

Concurrence:

Roy M. Beddow, RPP, MCIP

Deputy Director of Development Services

Concurrence:

Carl Johannsen, RPP, MCIP

Director of Development Services

Concurrence:

Hiro CHALL

For Rick Bomhof, P.Eng.

Director of Engineering, Parks &

Environment

Attachments

Concurrence:

Scott Kennedy, Fire Chief



Subject: Development Permit Application DP 04-22

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DEVELOPMENT PERMIT APPLICATION DP 04-22


Civic Address: 6141 200 Street

Legal Description: Lot B, Section 10, Township 8, New Westminster

District, Plan 84272

Applicant: Randy Olafson

Owner: Valley Properties Ltd.

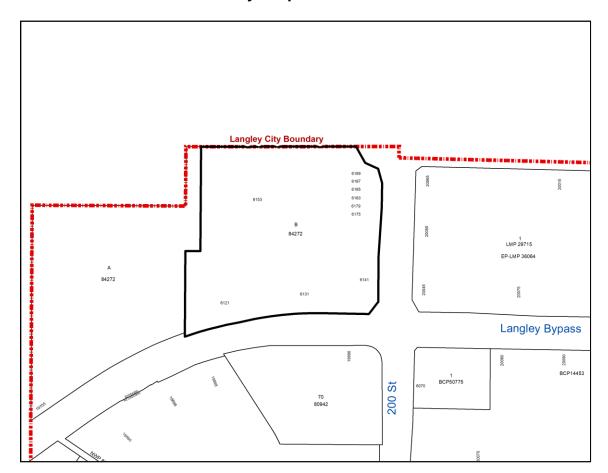



Project Data

www.cactusclubcafe.com

Code Analysis BCBC 2018

Zoning check list				Zoning Bylaw Reference / Note:
	6141 200th Street, City of			
civic address	Langley, BC V2Y 1A2 PID: 015-953-254 Lot B			
legal address	Section 10 Township 8 NWD Plan 84272 Survey drawing by Bennett			
survey	Land Surveying: " Topographic Survey of Part of Lot B Section 10 Township 8 NWD Plan 84272"			
zoning	NWD Plan 84272" C2 Service Commercial Zone			
occupancy classification	Group A-2, up to 2 Storeys			refer to BCBC 2018 table 3.1.2.1
number of stories	2 stories			
streets facing building	200 Street & Langley By-Pass (2)			
existing mall site area	47369.61 m2 (509882.24 ft2 or 11.70 acres)			area derived from COL's Webmap and based on the following despcription: 6131 200 ST Langley BC V2Y 1A2 PID: 015-953-254 (mal site area Willobrook Park)
existing mall gross floor area	10,425.12 m2 (112,177 ft2)			70 AT 201 10 10 10
existing gross floor area of subject CRU	591.71 m2 (6369.47 ft2)			area derived from "Topographic Survey of Part of Lot B Section 10 Township 8 NWD Plan 84272"
new gross floor area proposed to be added	502.64 m2 (5410.42 ft2)			refer to plan A0.05
open space area	proposed:	189.381 m2 (1,351.259 ft2) 17%		refer to plan A0.04
new mall approx. gross floor area	10,906.970 m2 (117,402.625 ft2)			refer to plan A0.05
new gross floor area of subject CRU Level 1	917.78m2 (9879.00 ft2)			refer to plan A0.05
new gross floor area of subject CRU Level 2	176.57m2 (1900.60 ft2)			
existing use of subject CRU	eating establishment			
proposed use of subject CRU	eating establishment			
density / floor area ratio (FAR)				Official Community Plan Bylaw Sevice Commercial
	allowed:	0.5 FAR (23,684.805 m2)		Serice Confinencial
	existing:	0.21 (10,425.12 m2)		
	proposed:	0.23 (10,927.760 m2)		
lot coverage				Part 3 Commercial Zones (C2)/5. Lo Coverage
	allowed:	90% (42,632.649 m2) 21% (10.425.12 m2)		refer to plan A0.05
	proposed:	23% (10,751.190 m2)		refer to plan A0.05
yards & setbacks				Part 3 Commercial Zones (C2V6
	required:		100000000000000000000000000000000000000	Siting of Building and Structures
		front: rear;	4.50m (14.76 ft) 0.0m (0.0 ft) 0.0m (0.0 ft) 4.50m (14.76 ft)	
		rear: interior: exterior:	0.0m (0.0 ft) 4.50m (14.76 ft)	
	proposed:	front:	4.50m (14.76 ft)	refer to plan A1.01
		rear. interior: exterior:	4.50m (14.76 ft) 0.0m (0.0 ft) 0.0m (0.0 ft) 4.50m (14.76 ft)	
		exterior:	4.50m (14.76 π)	Part 3 Commercial Zones (C2)/6.
building height	allowed: proposed.	15.0 m (49.21ft) 8.23 m (27.00ft)		Siting of Building and Structures
Water to control or const	proposed.			refer to plans A2.01-A2.02
Total parking count		637 parking stalls 5.6 spaces per		
existing parking ratio	for eviation was facilities	93m2 (1001.07 ft2)		
required parking	for existing use (eating establishment) of subject CRU:	325 regular stalls 17 HC		Part 1 Administration And Enforcement/E.4 (iii) Part 1 Administration And
		eating establishment	3.0 spaces per 93m2 (1001.07 ft2) of gross floor area or fraction	Enforcement/E. Off-Street Parking and Loading/4. Off Street Parking
	for proposed use (eating	GOLDANIA III POLIC	thereof	Requirements
	establishment) of subject CRU:			
		eating establishment	5.6 spaces per 93m2 (1001.07 ft2) of gross floor area or fraction	
	bicyle parking requirements	WC000370046023000	thereof	
bicycle parking	for existing use are the same as for the proposed use (eating establishment), therefore bicycle parking requierments are unchanged	eating establishment	Class I: 1.0 space per 500m2 of gross floor area or 1.0 space per 10 employees	Part 1 Administration And Enforcement/E: Off-Street Parking and Loading/10. Bicycle Parking Requirements
	existing:		28 bicycle spaces (7 racks)	
	required:		22 bicycle spaces	
loading	required:		1 space for 465 m2 (5005.38ft)	Part 1 Administration And Enforcement/E. Off-Street Parking and Loading/7. Loading
			2 space for 465 m2 -	Requirements
			2323 m2 (5005.38ft2 - 25005.38ft2) + 1 space each	
			additional 2323 m2	
			additional 2323 m2 (25005.38ft2) or	
	existing:		additional 2323 m2 (25005.38ft2) or fraction therof	
	existing.		additional 2323 m2 (25005.38ft2) or fraction therof	



King Taps Willowbrook

Architectural Symbols

Grid Bubble 1 Text Tag Note Now -----

Window Tag 🐵

Exterior Wall Tag (w) Partition Tag (PI)

Floor Tag 💮 - -Roof Tag (RI)

Door Tag Detail Tag

Building Section Marker

Revision Marker A

Plan Elevation Marker

Room Tag ROOM NAM

Interior Elevation 4002

Drawing Title 1A1,01 Drawing Trop 100 11:00 11:00

Project Description

Project includes full demolition of existing building. New building will include -Covered entry. -Main lounge. -Dining area.
-Covered patio
-Area for a seasonal patio. Service area such as:
-Washrooms (both men and women, including universal).
-Staff area. -Kitchen. -Storage. -Service platform. -Enclosed garbage area

Architectural Drawing List

A0 General A0.00 Cover
A0.01 Location Plan
A0.02 Existing Context Plan
A0.03 Existing/Proposed Site Overlay A0.02 A0.03 A0.04 A0.05 Code Analysis
Site Coverage Calculation
Site Coverage Plan
Demolition Plan A0.06 A0.07 A0.10 A0.11 A0.12 FAR Overlay Level 0 FAR Overlay Level 2 Existing Grade A0.13 A0.14 Proposed Grade Shadow Study A1 Plans

A1.00 Proposed Site Plan A1.01 Level O Plan A1.02 Level 2 A1.03 Roof Plan A2 Sections

A2.01 Sections A2.02 Sections A2.03 Sections A3 Elevations A3.01 Elevations A3.02 Elevations

A10 Signage A10.01 Signage Proposal

Landscape L0.0 L0.1 Cover Sheet Site Plan L0.1B L0.2 Planting Plan Sections

note: architectural drawings print full scale when printed at 22" x 34"

RSA

2 2022-88-02 DP Revision 3 4 2022-88-09 DP Revision 6

2022-03-08



KTWB

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6141 200 St Langley BC V2Y 1A2

scale NTS

reviewed by

Cover + Project Data

A0.00

Client **Project Manager** Architectural Landlord Valley Properties LTD. INC.NO.451978 Cactus Restaurants LTD Integrity Project Consulting Inc Tim Gilmour RSAAW Patrick Joyce 201-550 West Broadway Vancouver BC V5Z 1E9 Rafael Santa Ana Vancouver BC V5Z 4R3 CA 503 - 602 W Hastings St Vancouver BC V6B 1P2 6121 200 St 6 Langley BC V2Y 1A2 rsantaana@rsaaw.com 604.628.7881 patrickjoyce@c tgilmour@integrity-consulting.ca 604.506.7551 604.533.2102

www.integrity-consulting.ca

RSAAW.com

Interior Design Mechanical

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shaela@mckinl 604.785.3196 www.mckinlevstudios.com

www.smithandandersen.com

Mark Riendeau 300 - 6400 Roberts St Burnaby BC V5G 4C9

Smith + Andersen

604.294.8414

Electrical

Smith + Andersen Tim Tapar 300 - 6400 Roberts St Burnaby BC V5G 4C9

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MLegal@aplinmartin.com 604.803.7617

www.aplinmartin.com

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dylan@dkl.bc.ca 604.880.1721

www.dkl.bc.ca

Surveyor

Bennett Land Surveying LTD BC Land Surveyors 201 - 275 Fell Ave North Vancouver BC V7P 3R5

www.bennettsurveys.com 604.980.4868





2 View from 200 St looking North NTS



3 View from 200 St looking South NTS



1/80" = 1' 0"

4 Location Plan

RSA





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6141 200 St Langley BC V2Y 1A2

Location Plan



1 Existing Building from 200 St (East Elevation) NTS




2 Existing Building from parking (North Elevation) NTS



3 Existing Building from parking (West Elevation)



4 Existing Building from Langley Bypass (South Elevation)
NTS

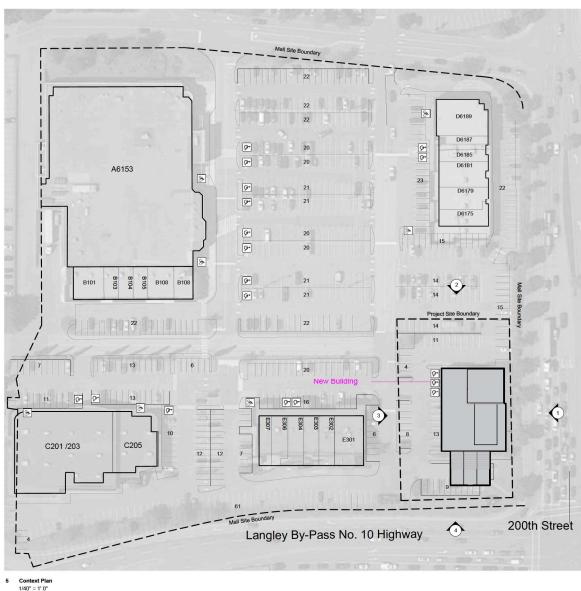

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Date Issue Notes
2022-03-08 Issued for Development Per

2023-01-13 Issued for Londlord Review 2023-01-30 Issued for Building Permit

2023-01-30 Issued for Building Po 2023-11-10 Issued for Developme

No. Date Revision Note

1 2022-05-09 DP Revision

1 2022-85-89 DP Revision 1 32 2022-46-13 DP Revision 2 32 2022-86-82 DP Revision 3

2022-88-82 DP Revision 3 4 2022-88-89 DP Revision 6

RSA AW

Rafael Santa Ana Architecture Workshop 503-602 W Hastings St Vancouver BC WR 192






6141 200 St Langley BC V2Y 1A2

ale drawn by DM
atus reviewed by RSA

Existing Context Plan

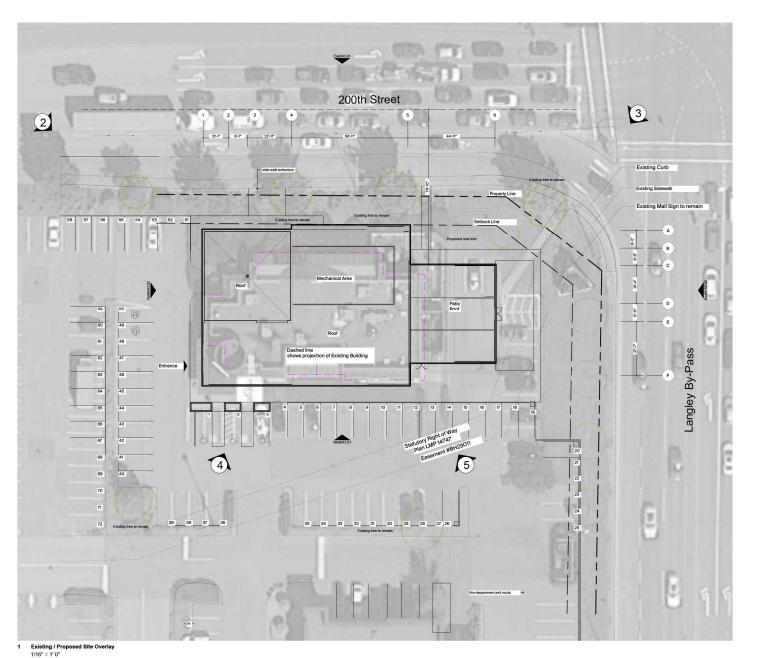



2 Existing trees on the sidewalk NTS



Pedestrian crosswalk NTS



4 Existing HC parking stalls NTS



5 Existing Garbage Area NTS

RSA AW Rafael Senta Ana Architecture Workshop Inc






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6141 200 St Langley BC V2Y 1A2

Existing/Proposed Site Overlay

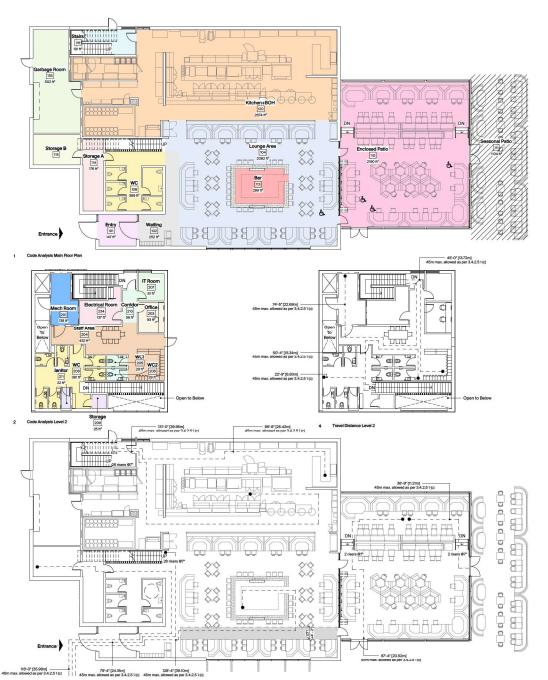

3 Travel Distance Main Floor Plan

Code Analysis BCBC 2018

Fire Rating

2 (200 Street & Langley ByPas 47369.61 m2 (509882.24 ft2 or 11.70 acres) Existing Mall Site Area

Previous Area 902.88m2 (9718.52 ft2)

3.2.2.27

3.2.2.27

Location of Exits/Travel Distance 3.4.2.5 (f)c) Max. travel distance required: 45 m

Required: 365x6.1mm= 2227.0 mm (min as per 3.4.3.2-A 800mm) Provided: 1x2007.0mm, 1x1855.0mm, 1x1800mm. 1x915mm table 3.4.3.2 - A

3.7.2.2 (6)

Occupant Load Calculation

Main Floor Plan

Room	Occupiab	le Area	Calculation	Occupant Loa
(101) Entrance	147.11 ft ²	14 m²	3.70m2/person	4
(102) Waiting	251.80 ft ²	23 m ²	3.70m2/person	7
(104) Lounge	2082.25 ft ²	193 m ²	seats=106	106
(108) WC	388.77 ft ²	36 m ²	N/A	Note 1*
(110) Patio	2190.13 ft ²	203 m ²	seats=132	132
(111) Seasonal Patio	1104.43 ft ²	103 m ²	seats=60	60
(113) Bar	299.06 ft ²	28 m ²	seats=23	23
(114) Storage A	175,67 ft ²	16 m ²	N/A	Note 1*
(115) Storage B	167.31 ft ²	16 m ²	N/A	Note 1*
(116) Stairs	190.81 ft ²	18 m²	N/A	Note 1*
(120) Kitchen + BOH	2673.77 ft ²	248 m ²	9.30m2/person	27
(133) Garbage Room	501.51 ft ²	47 m ²	N/A	Note 1*
Total	10172.62 ft ²	945 m ²		359

Iotai	10172.0211	940 III		359
Level 2				
(201) Mechanical Room	137.65 ft*	13 m²	N/A	Note 1*
(203) Office	92.60 ft ²	9 m²	9.30m2/person	1
(204) Staff Area	431.72 ft ²	40 m ²	9.30m2/person	5
(205) WC 1	28.19 ft ²	3 m²	N/A	Note 1*
(206) WC 2	28.44 ft ²	3 m²	N/A	Note 1*
(207) I/T Room	81.13 ft ²	8 m ²	N/A	Note 1*
(208) WC	380.81 ft ²	35 m ²	N/A	Note 1*
(209) Storage	24.51 ft ²	2 m²	N/A	Note 1*
(210) Corridor	55.57 ft ²	5 m ²	N/A	Note 1*
(211) Janitor	21.96 ft ²	2 m²	N/A	Note 1*
(234) Electrical Room	137.34 ft ²	13 m ²	N/A	Note 1*
Total	1419.91 ft ²	132 m²		6

OLF Occupancy as per 3.1.17.1 BCBC 2018 Kitchen 9.30m2/person Office 9.30m2/person BOH 46.00m2/person (storage)

Exit Width Calculation as per table 3.4.3.2 of BCBC 2018

	Factor as per 3.4.3.2 (1)	Occupant load	Required width	As per 3.4.3.2-A	Provided width
Exit Doorways	6.1mm	x	365 people	2,227.00m m	(800mm min)	1 x 2007.00mm 1 x 1855.00mm 72" 1800.00mm
Washroom	Calcul	atio	n			71°915mm

as per table 3.7.2.2 A of BCBC 2018

	People	# Of W	CRequirea	# of WC Provided
Occupant load	365 people			
Occupant load reduction as per table 3.7.2.2 (2)	-10 people			
Reduced occupant load	355			
	355/2			~~~~~
Male	178	as per table 3.7.2.2 A requires	4WC {	6 WC
Female	178 ple	as per table 3.7.2.2 A requires	8WC }	6 WC
Universal	people		- }	1WC
		Total	12 WC }	Total provided= 13 WC

Accessibility Compliance

sible seats Table 3.8.2.3 Minimum number required: 2 / Provided: 4

2022-03-08 Issued for Development Perm 2022-01-13 Issued for Landland Review 2022-01-30 Issued for Building Permit 2022-11-10 Issued for Development Perm










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6141 200 St Langley BC V2Y 1A2

scale 3/32" = 1'-0"	drawn by DM	
status DP	reviewed by RSA	

Code Analysis + Diagrams

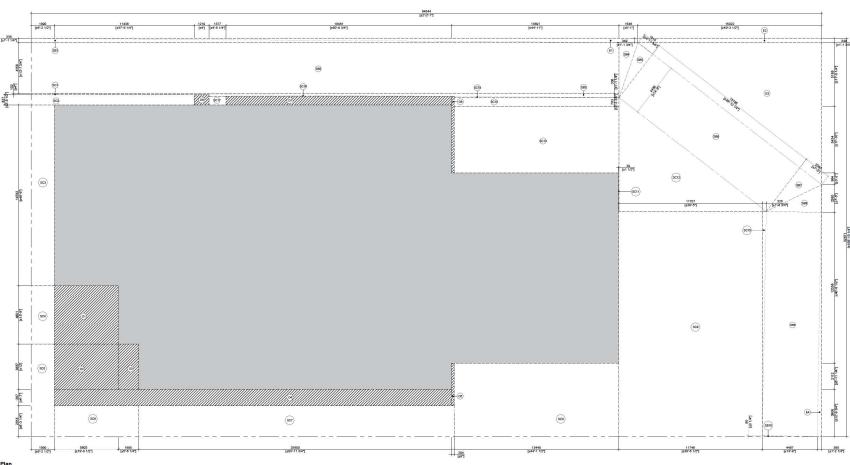

1 Overlay Site Plan

2 Site Coverage Calculation NTS

GROSS PERIMETER AREA					SITE COVERAGE O	ALCULATION		
	Width (mm) L	enght (mm)	Area (sq.m)				Width (mm) L	enght (mr
Gross Perimeter Area					Area Deductions			
	32572		2105.620 54.705sq.ftg		Exterior Space			
Area Deductions						SC1	182	25816
E	349	49023	8.659	(triangle)		SC2	827	25816
E	349	15022	5.243			SC3	1890	14782
E	11585	15022	87.015	(triangle)		SC4	1890	4901
E-	20837	365	3.768	(triangle)		SC5	1383	7564
						SC8	2518	7488
Subtotal			104.680			SC7	2518	25804
						308	0018	13448
Total Net Area			2000.930			SC9	11707	18459
		[21537	.831 sq. ft]			SC10	2674	1697
						SC11	39	3224
						SC12	9280	12033
						SC13	5434	13488
						SC14	703	13488
						SC15	95	13488
						SC16	105	19838
						SC17	686	1377
					Subtotal			

	1	Vidth (mm) L	enght (mm)	krea (sq.m)	
Area Deductions					
Setback					
	SB1	338	48076	8.125	(triangle)
	SB2	4158	48076	199,900	2 1000
	SB3	338	48076	8.125	(triangle)
	SB4	4495	1546	3.475	(triangle)
	\$85	1515	4498	3.408	(triangle)
	SB6	4498	15198	68.321	
	S87	2260	4498	5.080	(triangle)
	388	2200	4497	5.082	(triangle)
	589	18377	4497	82.641	
	SB10	80	4497	0.180	(triangle)
Subtotal				384.335	
Total Excludable E	cterior Area		1441	384.335 6.853 so.ftl	

	w	fidth (mm) L	enght (mm)A	(m.pr) sev	
Area Deductions	_		•		
Covered Areas	01	4801	5803	25.010	
	02	3657	5803	18.000	
	03	1685	3657	6.100	
	04	204	32500	45.000	
	05	203	3510	0.710	
	06	203	6230	1.260	
	07	690	18460	12.270	
	os	830	1220	1.000	
Subtotal				109.350	
Total Excludable In	terior Area		MM	109.350 7.043 sq.ft]	

BUILDING AREA		
	Width (mm) Lenght (mm)Area (sq.m)	
Gross Perimeter Area	32572 64845 2000.93	
Area Deductions		
Excludable Uncovered Area	973.752	
Excludable Covered Area	109.350	
Subtotal	1063.102	
Total Net Area	917.828 [9879.500 sq.ft]	

FAR Legend

- Included in FAR calculation
- Covered outdoor area, not included in FAR calculation
- Garbage enclosure, included in FAR calculation
- C Open areas, not included in FAR calculation
- Exterior wall assembly zone, included in FAR calculation

KTWB

0ate Issue Notes
2022-03-08 Issued for Development Period
2023-01-10 Issued for Landford Review
2023-01-10 Issued for Building Pernit
2023-11-10 Issued for Development Peri

2 2022-86-13 DP Revision 2 DPR2 2022-88-82 DP Revision 3 DPR2 2022-88-82 DP Revision 4 DPR4 2022-88-89 DPR4 2022-88-99 DPR4 20

RSA

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reviewed by


Site Coverage

A0.05

6141 200 St Langley BC V2Y 1A2

scale drawn by DM

Calculation

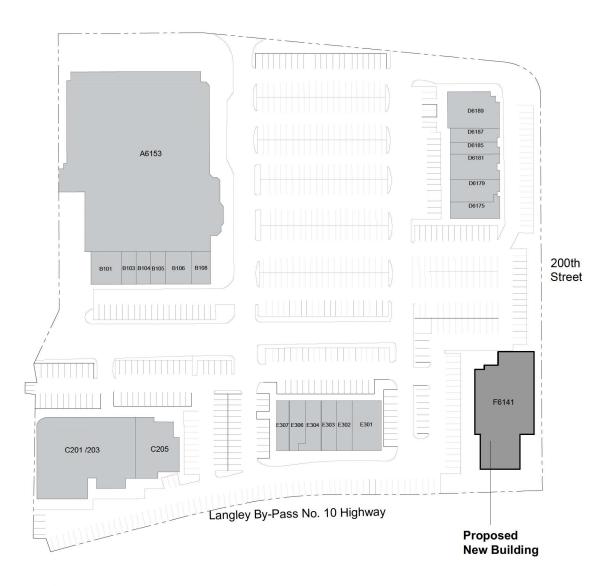

1 Context Plan

	Area (sq.m)	
Site Area	* 47369.617	
Area Aditions		
Zone A		
A6153	5048.351	SafeWay
Zone B		
B101	151.710	H & R Block
B103	81.197	Edward Jones
B104	81.011	Soccerwest
B105	78.967	CK Nail Salon
B106	143.906	Sally Beauty
B108	104.794	Insure BC
Zone C		
C201/203	1493.973	
C205	500.933	Optiks International
Zone D		
D6175		M & M Food Market
D6179		Jenny Craig
D6181		Global Pet Foods
D6185		Running Room
D6187		W. park Dental Center
D6189	414.161	Scotiabank
Zone E	220M/S **	D : 0
E301		Dairy Queen
E302		Wild Birds Unlimited
E303 E304		Sonu Haircut Pizza Hut
E306		Red Wings Shoes
E306 E307		Purolator
Proposal E307	113.003	ruolatoi
F6141	917.828	King Taps
Subtotal		
Total Net Area	10,751.190 [115,725.809 sq.ft]	

FAR Legend

Net Area of existing buildings in the site

Net Area of proposed building

* Site area based on information from City of Langley Data Base

Required by Law Parking

Required by Law 3 per 93m2

Required by Law 5% (of provided stalls) for accessible stalls

Required Parking

Regular stalls
Accessible
Total Provided: 325 17 342

Existing Parking

Regular stalls Accessible 637 Total Provided:

2 Site Coverage Summary

3 2022-88-02 OP Revision 3

RSA






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King Taps Willowbrook

6141 200 St Langley BC V2Y 1A2

reviewed by

Site Coverage Plan

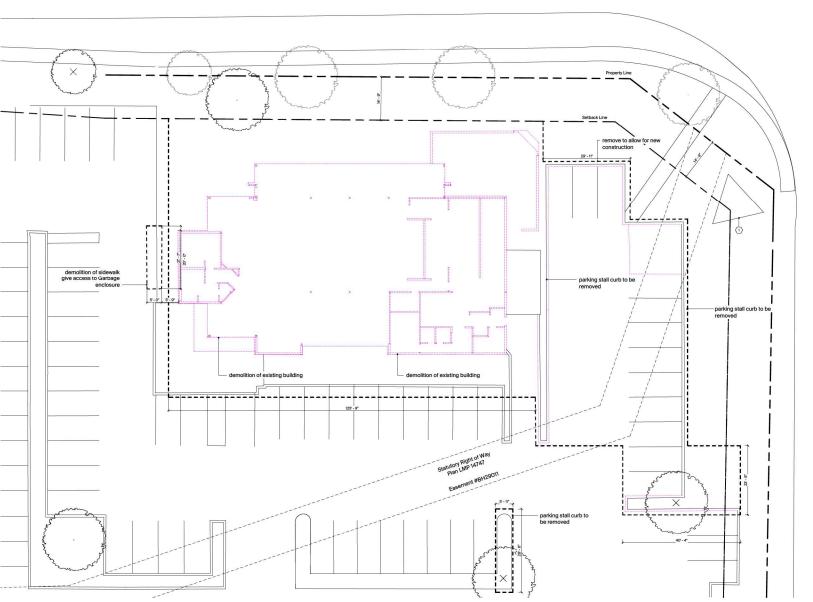

Legend





existing tree to be removed (refer to landscape)

Keynotes

1 Existing mall sign to remain

General Notes

All existing trees on site to remain unless noted otherwise.

3 2022-68-02 OP Revision 3

RSA






6141 200 St Langley BC V2Y 1A2

scale drawn by 3/32" = 1'-0" DM reviewed by

Demolition Plan

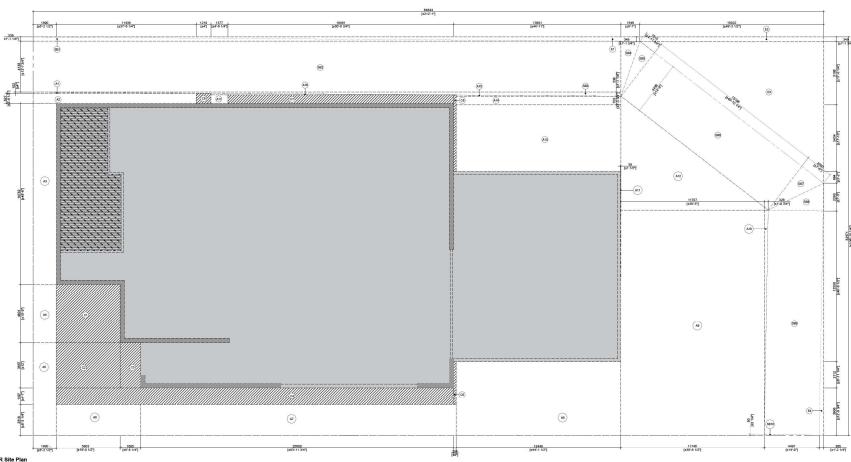

1 Overlay FAR Site Plan

2 FAR Calculation

ROSS PERIMETER AREA					SITE COVER
	Width (mm) L	enght (mm)	Area (sq.m)		
					Area Deduct
Bross Perimeter Area	32572	84845 [228	2105.620 64.705sq.ft]		Exterior Spar
Irea Deductions					
E1	349	49623	8.659	(triangle)	
E2	349	15022	5.243		
E3	11585	15022		(triangle)	
E4	20637	365	3.766	(triangle)	
iubtotal			104.680		
otal Net Area		(2153)	2000.930 (831 sq. ft)		7

	Width (mm) L	enght (mm)	Area (sq.m)	
Area Deductions				
Exterior Space				
A1	102	25816	0.745	(triangle)
A2	827	25816	11.028	
A3	1890	14782	27.937	
A4	1890	4801	9.073	
A5	1383	7564	14.314	
A6	2518	7488	17.357	
A7	2518	25804	64.893	
A8	6018	13448	80.995	
AB	11707	18459	216.818	
Att	2674	1697	4.538	(triangle)
A1	1 39	3224	0.123	
A1	9280	12033	55.833	(triangle)
A1	5434	13488	73.288	
A1-	4 703	13488	9.478	
A11	5 95	13488		(triangle)
Att	5 105	19838	1.414	(triangle)
All	7 696	1377	0.945	
Subtotal			589,417	
Total Excludable Exterior A	rea		589.417 44.485ng.ft]	

		Vidth (mm) L	enght (mm)	rea (sq.m)	
Area Deductions					
Setback					
	SB1	338	48078	8.125	(triangle)
	SB2	4158	48076	199,900	20000
	SB3	338	48076	8.125	(triangle)
	SB4	4496	1546	3.475	(triangle)
	\$85	1515	4496	3.406	(triangle)
	S86	4496	15196	68.321	
	SB7	2260	4496	5.080	(triangle)
	SB8	2200	4497	5.082	(triangle)
	SB9	18377	4407	82.641	
	SB10	80	4497	0.180	(triangle)
Subtotal				384,335	
Total Excludable Ex	terior Area		5412	384,335 6,893 sq.ft]	

Width (mm) Lenght (mm)Area (sq.m)					
Area Deductions	ea Deductions				_
Covered Areas	C1	4801	5803	25.010	
	C2	3057	5803	18.000	
	C3	1685	3657	6.100	
	C4	204	32500	45.000	
	C5	203	3510	0.710	
	C6	203	6230	1.260	
	C7	090	18450	12.270	
	CB	830	1220	1.000	
Subtotal				109.350	
Total Excludable Int	terior Area		1117	109.350 7.943 sq.ft3	

BUILDING AREA				
Width (mm) Lenght (mm)Area (sq.m)				
Gross Perimeter Area	32572	84845	2000.93	
Area Deductions				
Excludable Uncovered Area			973.752	
Excludable Covered Area			109.350	
Subtotal			1083.102	
Total Net Area			917.828 9.500 sq.ft]	

FAR Legend

- Included in FAR calculation
- ZZZ Covered outdoor area, not included in FAR calculation
- SSS Garbage enclosure, included in FAR calculation
- C Open areas, not included in FAR calculation
- Exterior wall assembly zone, included in FAR calculation

King Taps Willowbrook 6141 200 St Langley BC V2Y 1A2

KTWB


3 2022-88-02 DP Revision 3 4 2022-98-09 DP Revision 4 DPR4

RSA AW Rafael Senta Ana Architecture Workshop Inc.

scale drawn by DM

reviewed by

FAR Overlay Level 0

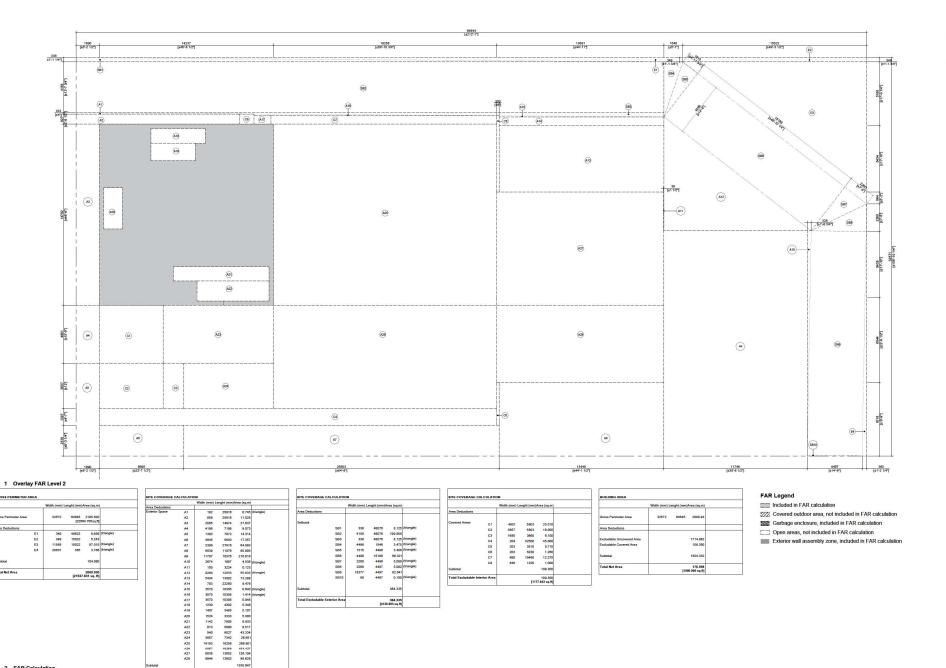

2 FAR Calculation

Bate Issue Notes
2822-43-08 Issued for Development Pern
2823-41-10 Issued for Building Pernit
2823-11-10 Issued for Building Pernit

2022-85-09 DP Revision 1
2022-85-13 DP Revision 2
2022-86-13 DP Revision 3
2022-88-02 DP Revision 3
2022-88-09 DP Revision 6

RSA






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scale drawn by reviewed by

FAR Overlay Level 2



Existing Average grade

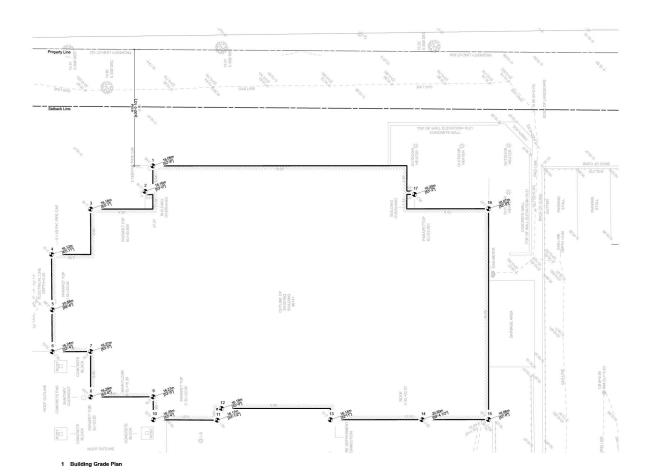as per topographic survey plan of part of LOT B Section 10 Township 8 NWD PLAN 84272.

Existing grades	Value
1	16.06m/52'-8"
2	16.16m/53'-0"
3	16.18m/53'-1"
4	16.12m/52'-11"
5	20.88m/68'-6"
6	16.24m/53'-4"
7	16.27m/53'-5"
7 8	16,29m/53'-6"
9	16.27m/53'-5"
10	16.25m/53'-4"
11	16.17m/53'-1/2"
12	16,16m/53'-0"
13	16.14m/52'-11"
14	20.85m/68'-4 1/2"
15	16.06m/52'-8"
16	16.07m/52'-8"
17	16.20m/53'-2"
Subtotal	284.37m/932'-11 3/4"
verage natural grade (284.37/17)	16.73m/54'-10"

*Survey plan 84272 info. shown only for grade references.

2 Existing Average Grade Summary

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2023-01-30 Issued for Building Permit

No. Date Revision Notes

1 2022-45-49 DP Revision 1

2022-46-11 DP Revision 2

2022-48-12 DP Revision 3

4 2022-48-49 DP Revision 4

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6141 200 St Langley BC V2Y 1A2

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DP	RSA

Existing Grade

Average Grades

Proposed grades	Value
1	16.07m/52'-8
2	16.27m/53'-5
3	16.18m/53'-1"
4	16.24m/53'-4
5	16.27m/53'-5
6	16.27m/53'-5
7	16.29m/53'-5
	16.16m/53'-0
9	16.14m/52'-11
10	16.06m/52'-8
11	16.06m/52'-8
12	16.23m/53'-4
13	15.90m/52'-2
14	15.91m/52'-2'
15	15.99m/52'-6
16	16.02m/52'-5
17	16.08m/52'-9
18	16.07m/52'-8
19	16.00m/52'-6
20	16.00m/52'-6
21	16 Olm/52'-6

338.21m/1109'-7"

Average natural grade (354.23/22) 16.10m/52'-10"

* Refer to Survey plan 84272 for existing grading.









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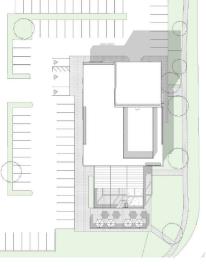
6141 200 St Langley BC V2Y 1A2


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Proposed Average Grade





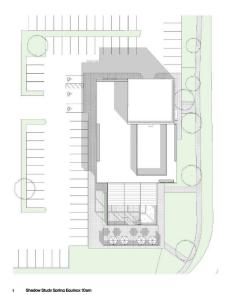


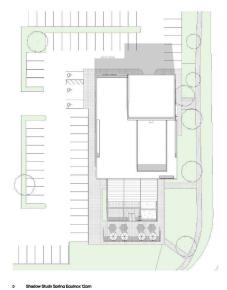


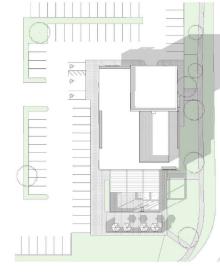
Date Issue Notes
2022-03-08 Issued for Development Perm
2023-01-13 Issued for Landland Review
2023-01-30 Issued for Building Permit
2022-11-10 Issued for Development Perm

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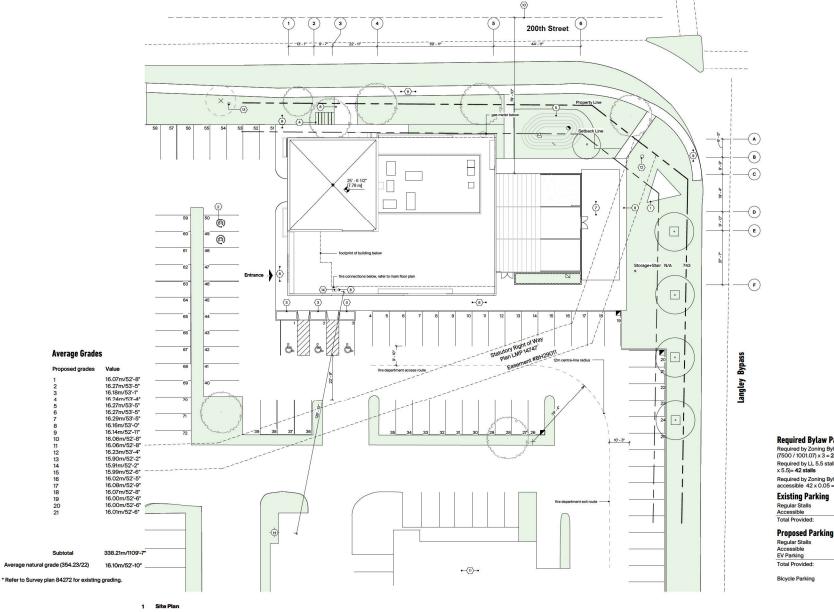
A0.14

Shadow Study

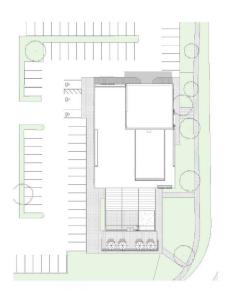KTWB King Taps Willowbrook

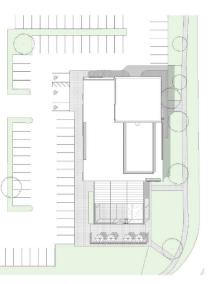6141 200 St Langley BC V2Y 1A2

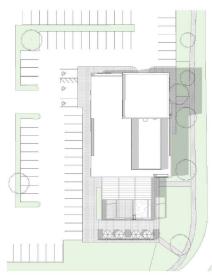reviewed by



1/16" = 1'-0"

Keynotes

- 1 Existing mall sign to remai
- 2 EV charging station
- 4 bike rack
- 7 seasonal patio
- 8 new sidewalk
- 9 existing sidewalk
- (11) existing building
- (12) Existing Storm Manhole. Refer to Survey
- 13 Proposed Sanitary Manhole
- fire department lock box (recessed into

Legend

- existing tree to be removed (refer to landscape)
- (refer to landscape)
 existing tree to remain
- proposed new tree
- proposed planting (EV stall
- existing fire hydran
- accessible parking stall lawn area
- Nawn basin △ bioswale inlet

Required Bylaw Parking
Required by Zoning Bylaw 3 stalls per 93m2 (1001.07ft)
(7500 / 1001.07) x 3 = 23 stalls Required by LL 5.5 stalls per 1000 ft2 (7.5 x 5.5)= **42 stalls**

Required by Zoning Bylaw 5% (of provided stalls) for accessible 42 x 0.05 = 2 stalls

Regular Stalls Accessible	54
Total Provided:	56

Regular Stalls	67
Accessible	3
EV Parking	2
Total Provided:	72

Date Issue Notes
2022-00-08 Issued for Development Permit
2022-01-13 Issued for Landland Review
2022-01-00 Issued for Building Permit
2022-11-10 Issued for Development Permit

2022-68-02 DP Revision 3

2022-68-09 OP Revision 4

RSA






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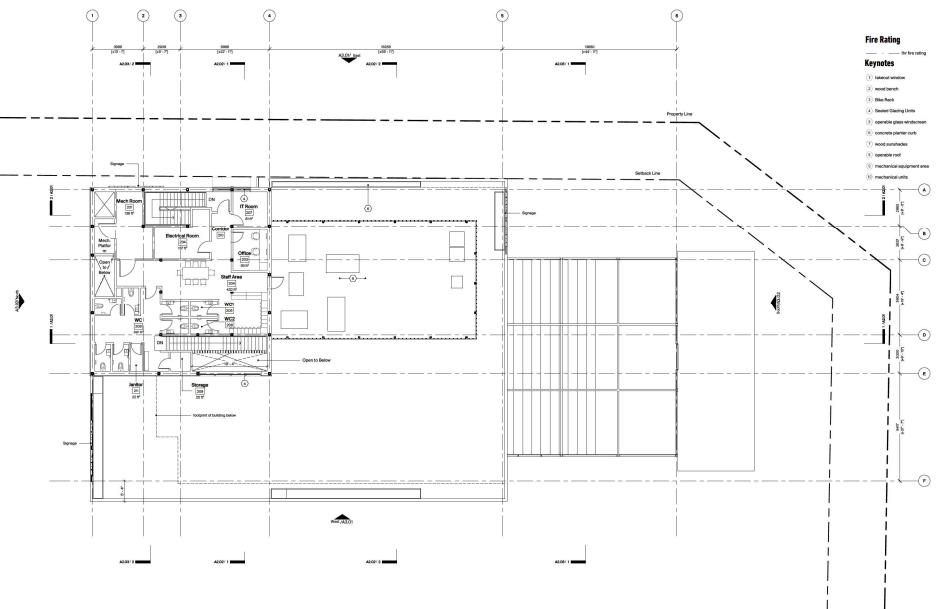
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status	reviewed by

Proposed Site Plan

A1.00



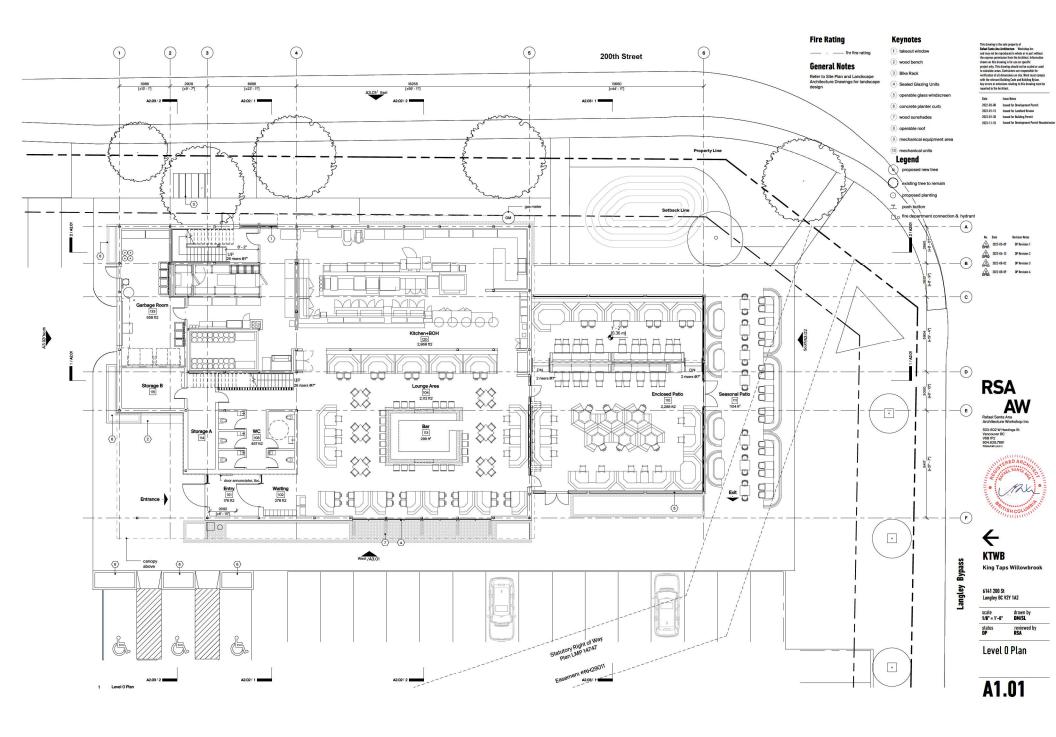

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2022-03-08 Issued for Development Permit
2022-01-13 Issued for Landland Review
2022-01-10 Issued for Building Permit
2022-11-10 Issued for Development Permit Resubmin

6a. Date Revision Notes
2022-65-69 CP Revision 1
2022-64-13 CP Revision 2
2022-66-02 CP Revision 3

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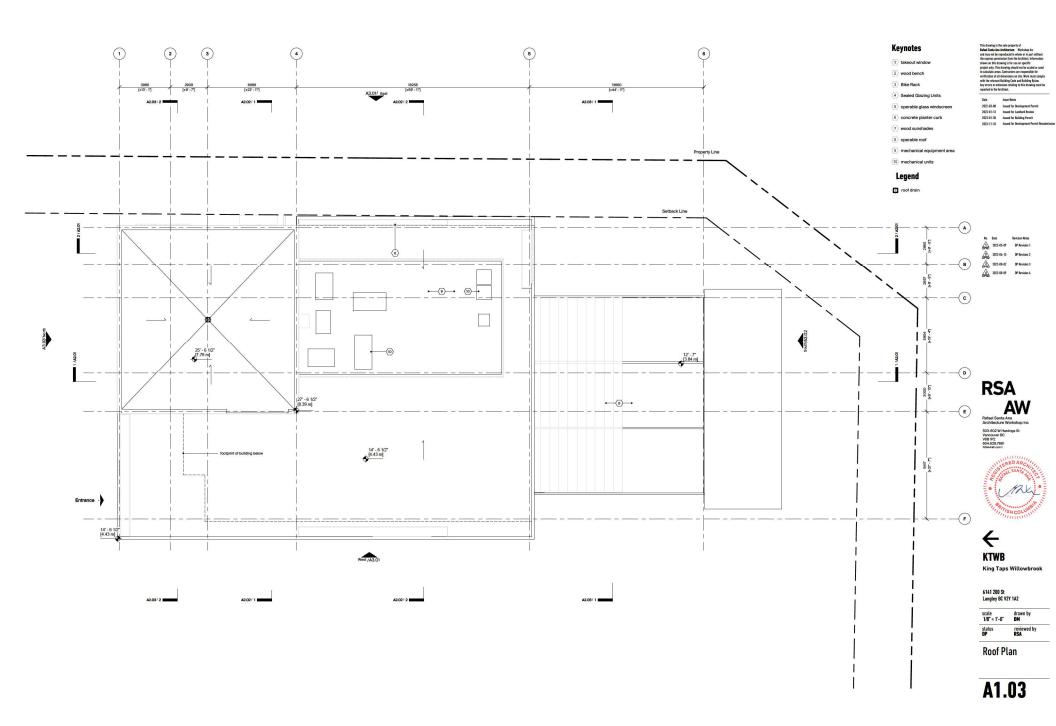



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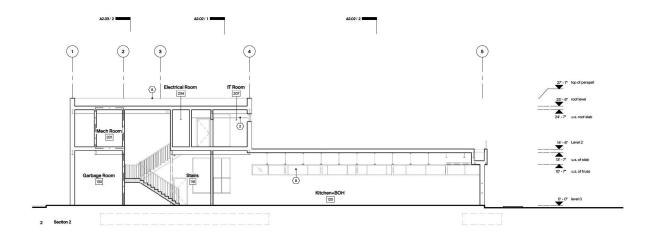
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Level 2 Plan

A1.02





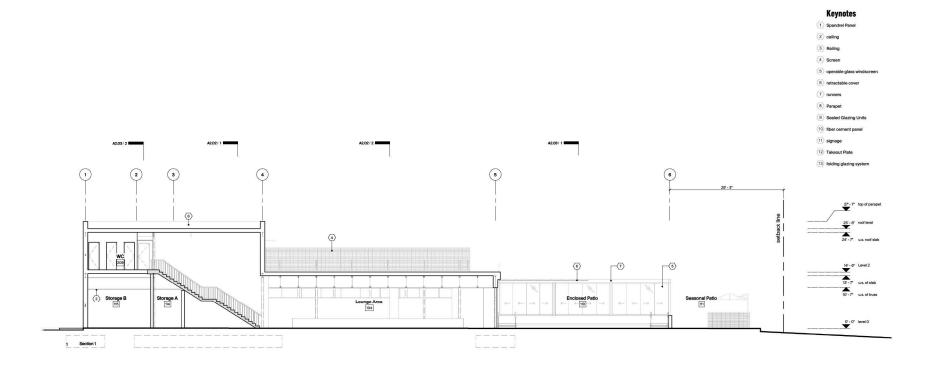

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2023-01-30 Issued for Buildine Permit

No. Date Revision Notes

2022-65-09 DP Revision 1

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2022-68-09 DP Revision 3

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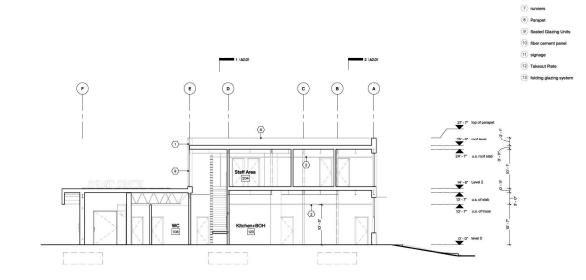
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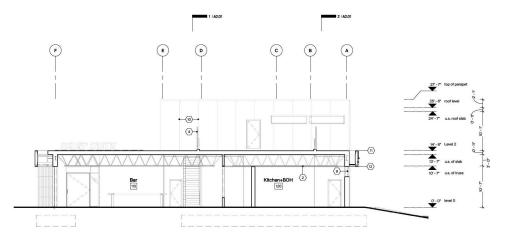
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Sections

A2.01





2 Section

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Keynotes

1 Spandrel Panel

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2022-01-30 Issued for Building Permit
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No. Date Revision Notes

2022-45-09 DP Revision 1

2022-45-19 DP Revision 2

2022-46-13 DP Revision 2

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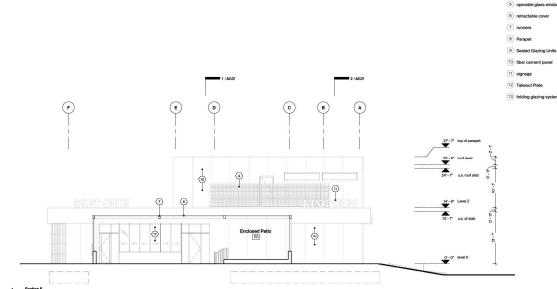
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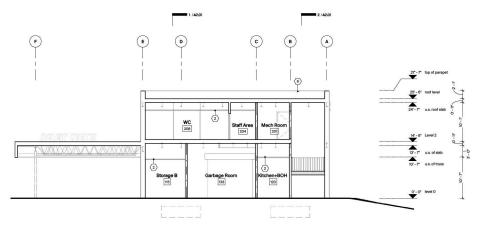
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Sections

A2.02





Keynotes

1 Spandrel Panel

(2) ceiling

Date Issue Notes
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2022-01-13 Issued for Landland Review
2022-01-30 Issued for Building Permit
2022-11-10 Issued for Development Permit

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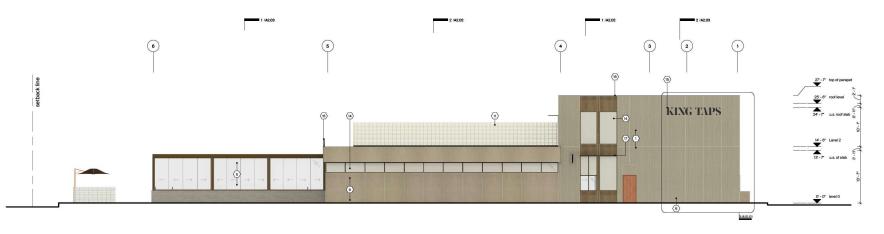
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Sections

A2.03





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Date Issue Notes
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2022-01-30 Issued for Building Permit
2022-11-10 Issued for Development Permit Result

No. Date Revision Notes

2022-65-09 DP Revision 1

2022-65-09 DP Revision 2

DP Revision 3

DP Revision 3

DP Revision 3

DP Revision 4

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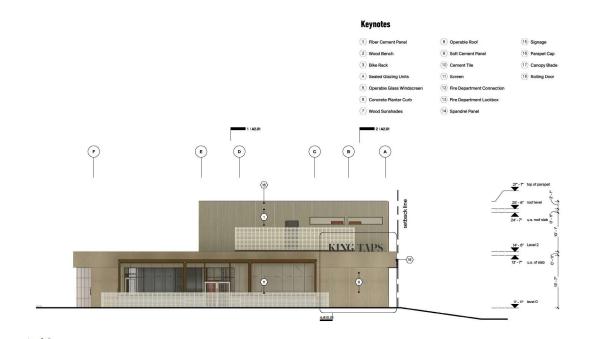
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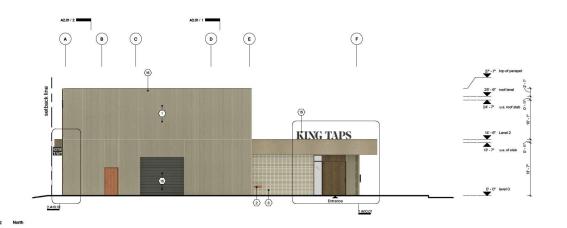
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Elevations

A3.01





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2023-40-10 Issued for Landaud Review
2023-40-10 Issued for Building Permit
2023-11-10 Issued for Development Permit Resul

Ma. Date Revision Notes

2022-45-09 DP Revision 1

2022-46-13 DP Revision 2

2022-46-02 DP Revision 3

2022-46-07 DP Revision 3

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KTWB


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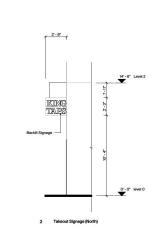
6141 200 St Langley BC V2Y 1A2


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1/8" = 1'-0"	DM
status	reviewed by
DP	RSA


Elevations


A3.02



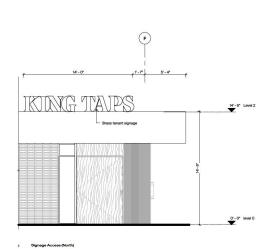

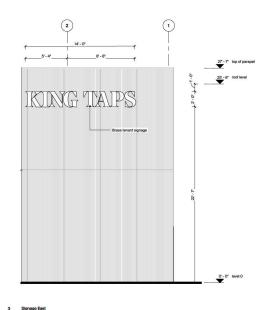

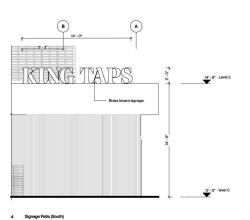

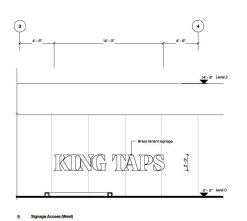

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Date Issue Notes
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2022-01-13 Issued for Landland Review
2022-01-30 Issued for Building Permit

No. Date Revision Notes
2022-65-09 EP Revision 1
2022-66-13 EP Revision 2
2022-66-13 EP Revision 2

RSA AW Refael Santa Ana Architecture Workshop Inc 503-602 W Hastings St



KTWB King Taps Willowbrook

> 6141 200 St Langley BC V2Y 1A2

scale drawn by
1/4" = 1'-0" DM

status reviewed by
DP RSA

Signage Proposal

A10.01















VIEW FROM SOUTH EAST CORNER ALONG 200 ST





LANDSCAPE DRAWING LIST

1.0.0	COVER SHEET
L0.1	SITE PLAN
L0.1B	PLANTING PLAN
L0.2	SECTIONS
102	DETAILO

LANDSCAPE NOTES

- 1. For all grading information REFER TO CIVIL.
- 2. For zoning, vicinity map and legal information REFER TO ARCHITECTURAL.
- 3. For the dimensioned Site Plan REFER TO ARCHITECTURAL.
- 4. For all layout and centreline information REFER TO ARCHITECTURAL and CIVIL.
- 5. Lighting to be at safety levels with accent lighting in key areas REFER TO ELECTRICAL.

IRRIGATION NOTES

- 1. Irrigation to be provided for all 'Soft Landscape Areas' shown on the drawing.
- Irrigated areas to be installed as a design build irrigation system from the stub outs provided. Provide submittals of design to consultant at least one week prior to installation and as-built drawing within one montl of substantial performance.
- The irrigation system design and installation shall be in accordance with the Irrigation Industry of BC Standards and Guidelines.

PLANTING NOTES

- 1. All work shall meet or exceed the requirements as outlined in the Current Edition of the Canadian. Landscape
- 2. Plant sizes and related container classes are specified according to the Current Edition of the Canadian. Landscape Standard. For container classes #3 and smaller, plant sizes shall be as shown in the plant list and the Standard, for all other plants, both plant size and container class shall be as shown in the plant list. Specifically, when the plant list call for #5 class containers, these shall be as defined in the CNLA (ANSI) Standard.
- 3. All trees to be staked in accordance with CNLA Standards.
- 4. Tree caliper shall be a minimum of 6cm.

PLANT LIST

SYMBOLS	NUMBER	BOTANICAL NAME	CONMON NAME	Size/Specing
	1	Acer platanoides	Norway Maple	2 * Cal. B&B
	4	Acer x freemanii 'Autumn Blaze'	Autumn Blaze Maple	2" Cal. Specimen
0	1	Cercis canadensis	Eastern Redbud	2" Cal. Specimen
. RE	NNIALS & GR	OUNDCOVERS		
evweere	Numbers	BETTOREN, WWE	earmen world	OtorOpening
Ag	17	Azalea x 'Girard's Pleasant White'	Girard's Pleasant White Azalea	#2 pot / 24" O.C.
Bw	156	Buxus microphylla 'Winter Gern'	Winter Gem Boxwood	#2 pot / 18" O.C.
cl	151	Calamagrostis x acutiflora 'Karl Foer	ster Foerster'S Feather Reed Grass	#5 pot
Сь	2	Callicarpa bodinieri	Profusion Beautyberry	#5 pot
fc	143	Fragaria Chiloensis	Beach Strawberry	10cm Pot 18" O.C
ī	67	Iris sibirica	Siberian Iris	#1 pot /12* O.C.
je	37	Juncus effusus	Soft Common Rush	#1 pot / 12" O.C.

Date	Issue Notes
22-05-06	ISSUE FOR DP
22-05-09	RESPONSE FOR DP COMMEN
22-06-13	ADP MEETING

22-06-13	ADP MEETING
22-06-27	ADP SUBMISSION REVIEW
22-09-09	ISSUE FOR ADP
22-09-29	REVISED PER CITY COMMENTS

2-09-29	REVISED PER CITY COMMENTS
3-11-14	RESSUED FOR DP





KTWB King Taps Willowbrook


#3 pot / 24" O.C.

#2 pot / 24" O.C.

#1 pot / 12"O. C.

6141 200 St Langley BC V2Y 1A2 scale As indicated

COVER SHEET

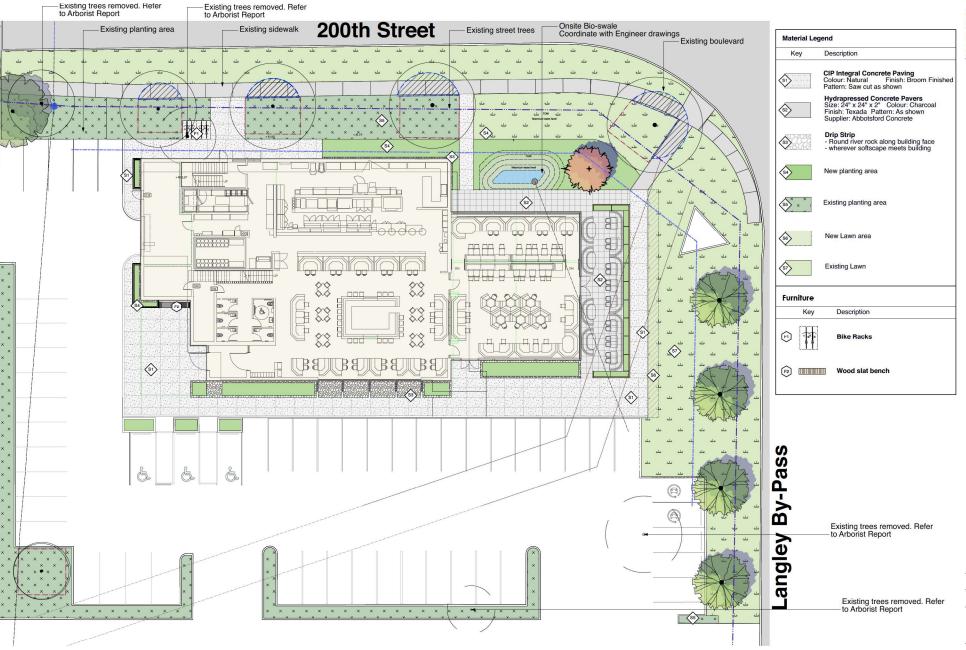

22-05-06 ISSUE FOR DP RESPONSE FOR DP COM 22-06-13 ADP MEETING

22-06-29 ADP SUBMISSION REV 22-09-09 ISSUE FOR ADP

22-09-29 REVISED PER CITY CO 23-11-14 RBSSUED FOR DP



DUSANTE KROUKLED. LANCSCAPE ARCHITECTS 102 - 1007 Weel St. Avenue Vancourie S.C. Vill 198 PS94.694-4011 | F694.694-2077 | www.dkibc.co

Langley BC V2Y 1A2

scale drawn by 3/32" = 1' O" AL/DC status DP

SITE PLAN


KTWB

6141 200 St

King Taps Willowbrook

L 0.1

200th Street

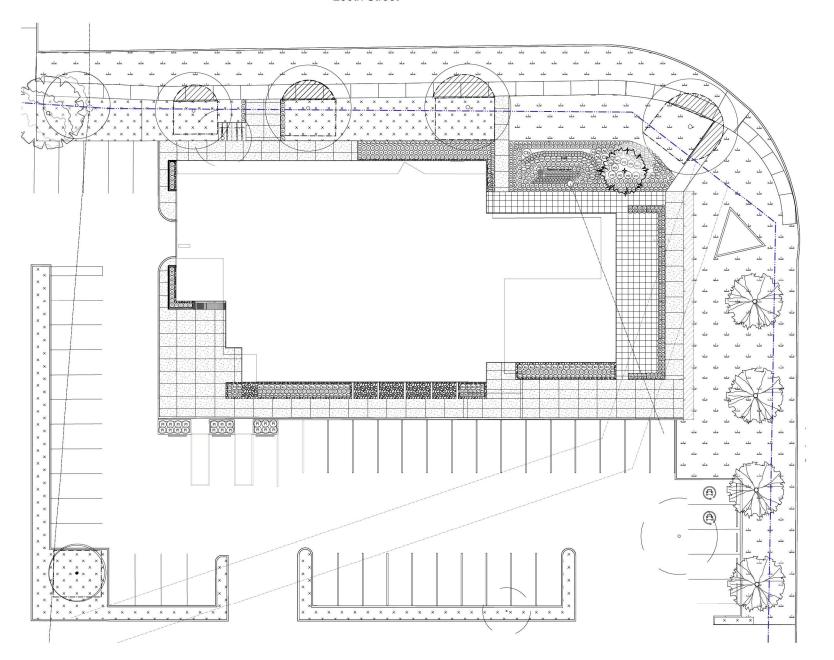

22-06-13 ADP MEETING
22-06-29 ADP SUBMISSION R
22-09-09 ISSUE FOR ADP
22-09-29 REVISED PER CITY C
23-11-14 RBSSUED FOR DP





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6141 200 St Langley BC V2Y 1A2


scale drawn by 3/32" = 1' O" AL/DC

PLANTING PLAN

L 0.1B



22-05-06 ISSUE FOR DP
22-05-09 RESERVANTE FOR DP CO
22-06-13 ADP MEETING
22-06-27 ADP SUBMISSION REVI
22-06-29 REVISED FOR CDP
22-06-29 REVISED FOR CDP
22-06-29 REVISED FOR CDP
23-11-14 RESSUED FOR CDP

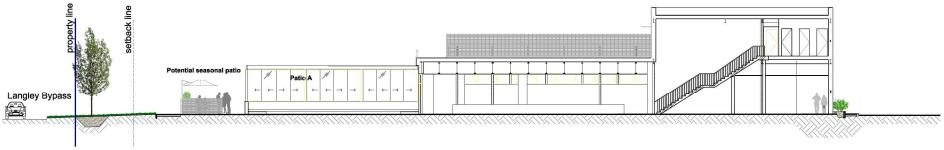



RSA

KTWB


King Taps Willowbrook

6141 200 St Langley BC V2Y 1A2 scale As indicated

status


SECTIONS

L 0.2

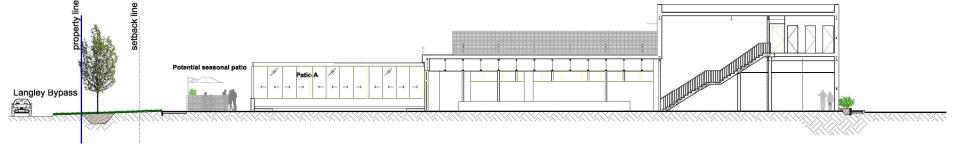


Sectoion through western and eastern site

Scale: 1:96

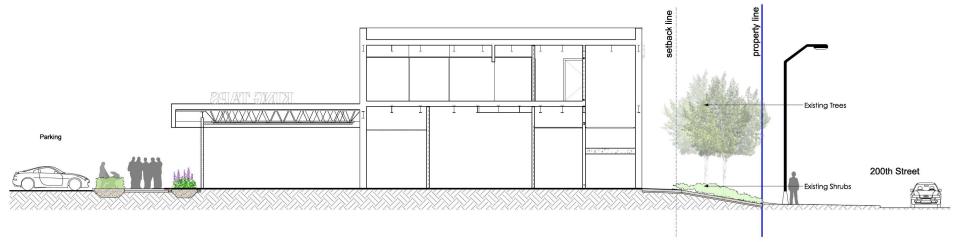

Sectoion through northern and southern site

Scale: 1:64

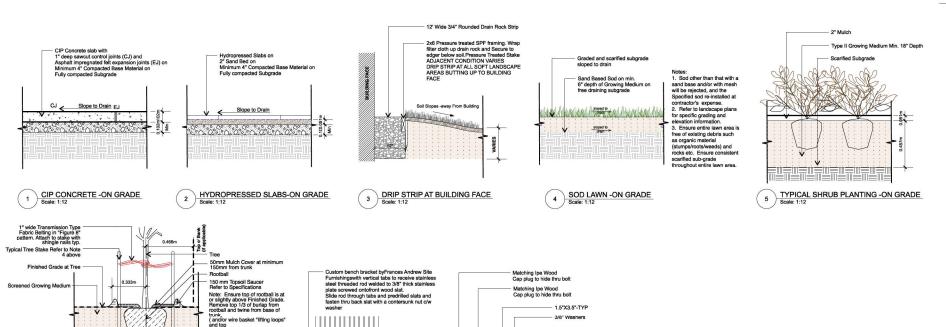

Refer to structural for Reinforcing, Footing and Base Build up

ple

proper

Soil le

600

450

2.6 M x 2.6 M

3.3 M x 3.3 M

29M x 29M

vral Notes:

Do not cut Tree Leader.

Protect tree from daten ged uring planting. Ensure rootball protected from Sun, Frost or Desiccation.

Ensure tree loaden does not conflict with Underground Services. "Call before digging."

All street trees to be staked with 2 - 100mm/3 x 25m long. Minimum depth of stake embedment is 1m. Ensure stakes to mot penetrate or dramage rootball. Ensure all stakes are adopted parallet to sidewalk/road on tree pit

3.80 M Ø

3 25 M Ø

centreline.


Provide min. 5 cubic meters of growing medium per tree.

Refer to Growing Medium Chart below for surface area depth of Growing Medium.

Depth of Growing | Variation 1 | Variation 2 | Variation 2 | Variation 2 | Variation 3 | Variation 4 | Variation 4 | Variation 5 | Variation 6 | Variation 6 | Variation 6 | Variation 6 | Variation 7 | Variation 6 | Variation 7 | Variation 7

11.11

8 33

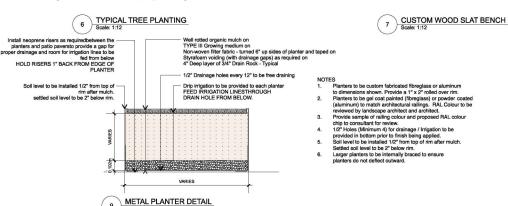


row of basket). Remove

Bottom of pit. Compact subgrade under rootball only to prevent settlement - min. 95% S.P.D.

any soil on top of "original" rootball.

Scarify tree pit sides and bottom. Do not "compact".

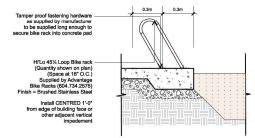

BIKE RACK MOUNTING -HORIZONTAL

Any errors or omissions relating to this drawin reported to the Architect.	
Date	Issue Notes

22-05-06 ISSUE FOR DP RESPONSE FOR DP COMMENT 22-05-09 22-06-13 ADP MEETING

ADP SUBMISSION REVE 22-09-09 ISSUE FOR ADP

22-09-29 REVISED PER CITY COMMENTS 23-11-14 RBSSUED FOR DP









6141 200 St Langley BC V2Y 1A2 drawn by scale As indicated status DP

L 0.3